

Agenda Item No. 8e.

Staff Report

Date: June 13, 2024

To: Mayor Kircher and Council Members

From: Richard Simonitch, Public Works Director

Subject: Award of Construction Contract for the Laurel Grove Safe Pathway Project Phase

II-B between Monte Alegra and Canyon Road to Bauman Landscape and

Construction, Inc. in the amount \$539,334 – Town Project No. 9075-45B

Recommendation

It is recommended that the Town Council award the construction contract for the Laurel Grove Safe Pathway Project Phase II-B between Monte Allegra and Canyon Road and authorize the Town Manager to enter into a construction contract with Bauman Landscape and Construction, Inc. in the amount of \$539,334; and authorize a contingency of up to \$27,000 for potential change orders to address unforeseen conditions.

Background & Discussion

The work to be performed under this contract consists of installing 400 feet of new asphalt pathway and concrete barrier from the terminus of the Phase IIA project near the private driveway known as "Monte Alegra" to just past the intersection at Canyon Road. The work will involve complete reconstruction of the Laurel Grove pavement within the project limits, with new lane striping and stamped asphalt pedestrian "havens" at Canyon Road, and repainting of the havens at Walters Road and Monte Alegre. 100 feet of decorative concrete retaining wall and new landscaping will be installed along the property frontage of 77 Laurel Grove as part of this phase. The project drawings are attached to this staff report.

BKF Engineers were contracted to review existing conditions and provide the engineering design and specifications for the project. The engineer's estimate was \$430,400. Because of the estimated cost of the project, the formal bidding procedure was used. The project was advertised for bid on May 10, 2024, and four bids were received and opened on June 6th 2024. Bauman Landscape and Construction, Inc. is the lowest responsive and responsible bidder in the amount of \$539,334.00. The total is roughly 25% higher than the engineer's estimate.

All of the bids that were received are tabulated from low to high bidder as follows:

Bauman Landscape and Construction, Inc.	\$ 539,334
W.R. Forde Associates, Inc.	\$ 587,643
Maggiora & Ghilotti	\$ 651,944
Ghilotti Bros.	\$ 668,666

Fiscal, resource and timeline impacts

Staff is requesting that an approximate 5% ministerial contingency of \$27,000 be available for use by the Town Manager for unforeseen changes should they arise. Adding the contingency, BKF Engineers design and estimated construction management services costs of \$175,000 bring the total project cost for Phase IIA and IIB combined to approximately \$950,000 over the past three years beginning in fiscal year 2022-2023. The project is funded under account no. 9075-45 under the gas tax fund and roadway fund for fiscal year 2023-24 and fiscal year 2024-25 including a \$400,000 grant from TAM Measure AA funds. Construction is expected to begin soon after the July 4th holiday and the contractor is allowed 40 working days, resulting in project completion by mid-August 2024.

Alternative actions

Considering that the low bid is 25% higher than the engineer's estimate, the Town Council could request that the current bid be rejected, and the project re-advertised with the hope of receiving lower bids. Staff recommends that the current bid be considered reasonable and accurate with respect to the higher bid received from Ghilotti Bros., escalating construction costs, and bidding climate, and that re-advertising the project for new bids will not likely result in lower bids.

Environmental review

The project is categorically exempt under the California Environmental Quality Act (CEQA) Article 19, Section 15301 existing facilities (existing highways and streets).

Attachments


Project Plans

CONSTRUCTION DRAWINGS FOR

LAUREL GROVE AVENUE

SAFE PATHWAY TO SCHOOL PHASE II-B TOWN OF ROSS, CALIFORNIA

MAY 2024

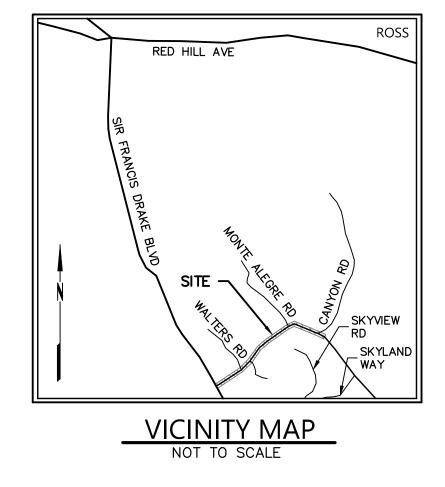

INDEX OF DRAWINGS

SHEET	<u>TITLE</u>	NUMBER
CV-1	COVER SHEET	1
GN-1	GENERAL NOTES	2
TS-1	TYPICAL ROADWAY SECTIONS	3
OP-1	HORIZONTAL CONTROL PLAN AND KEY MAP	4
DM-1	DEMOLITION PLAN & SEDIMENT CONTROL PLAN	5
GR-1	GRADING & PAVING PLAN	6
PD-1	PAVEMENT DELINEATION PLAN	7
PD-2	PAVEMENT DELINEATION PLAN (DETAILS)	8
S-1	SIGNAGE PLAN	9
DT-1	INTERSECTION DETAIL	10
RW-1	RETAINING PLAN, PROFILE & DETAILS	11
CD-1	CONSTRUCTION DETAILS	12
L-1.1	PLANTING PLAN	13
L-1.2	IRRIGATION PLAN	14

ABBREVIATIONS

±	MORE OR LESS (CONFORM TO EG)	МН	MANHOLE
AB	AGGREGATE BASÈ	MIN	MINIMUM
AC	ASPHALT CONCRETE	NO	NUMBER
APN	ASSESSOR'S PARCEL NUMBER		
BFP	BACKFLOW PREVENTER	OH	
BLRD	BOLLARD	PL	
BM	BENCHMARK	PUE	
CB	CATCH BASIN	PVT	
CL	CENTERLINE	R	
CL2	CLASS II	RCP	
CO	CLEAN OUT	RSPR	RIPRAP ROCK SLOPE PROTECTIO
CONC	CONCRETE	RTWL	
CY	CUBIC YARD	R/W	
DDC	DOUBLE DETECTOR CHECK	S=	SLOPE
DI	DROP INLET	SD	STORM DRAIN
DIA	DIAMETER	SDMH	STORM DRAIN MANHOLE
DN	DOCUMENT NUMBER	SF	
DW	DRIVEWAY	SL	STREETLIGHT
Ε	ELECTRIC	SS	SANITARY SEWER
EG	EXISTING GROUND	SSMH	
	ELEVATION	STA	STATION
EP		STD	STANDARD
ESMT	EASEMENT	ТВ	TOP OF BOX
EX	EXISTING	TC	TOP FACE OF CURB
FG	FINISHED GRADE	TEL	TELECOMMUNICATION LINE
FH	FIRE HYDRANT	TF	TRANSFORMER
FL	SURFACE FLOWLINE	TG	TOP OF GRATE
FT	FOOT	TW	TOP OF WALL
G	GAS	TYP	TYPICAL
GB	GRADE BREAK	UB	UTILITY BOX
GI	GRATE INLET	UP	
GM	GAS METER	UT	
HORZ	HORIZONTAL	VC	
HT	HEIGHT	VERT	
IN		VLT	
INV		W	
1	I FNGTH	WM	WATER METER

BFP BLRD BM CB CCONC CONC DIA DW EGLEV ESMT EX FHLT GB GI HT INV L	BOLLARD BENCHMARK CATCH BASIN CENTERLINE CLASS II CLEAN OUT CONCRETE CUBIC YARD DOUBLE DETECTOR CHECK DROP INLET DIAMETER DOCUMENT NUMBER DRIVEWAY ELECTRIC EXISTING GROUND ELEVATION EDGE OF PAVEMENT EXISTING FINISHED GRADE FIRE HYDRANT SURFACE FLOWLINE FOOT GAS GRADE BREAK GRATE INLET GAS METER HORIZONTAL HEIGHT INSTRUMENT NUMBER BOTTOM INSIDE OF PIPE LENGTH	MIN NOTS OH PUE PVT R RCP RSPR RTW SSD SSTA STD TE TG TYP UP VC VERT VLT	NUMBER NOT TO SCALE OVERHEAD UTILITY LINE PROPERTY LINE PUBLIC UTILITY EASEMENT PRIVATE RADIUS REINFORCED CONCRETE PIPE RIPRAP ROCK SLOPE PROTEC RETAINING WALL RIGHT OF WAY SLOPE STORM DRAIN STORM DRAIN MANHOLE SQUARE FEET
MAX	MAXIMUM		

____UT____ _____E___ _____ G ____

210182-10_IMPR.dwg

SYMBOLS & LEGEND

SIZE" SD

SIZE"WW

BENCHMARK

BLOW OFF

UTILITY POLE **GUY ANCHOR** CATCH BASIN

GAS MANHOLE

TREE TO BE REMOVED

PROPERTY LINE EASEMENT CENTERLINE

SANITARY SEWER

OVERHEAD UTILITY LINE UNDERGROUND UTILITY LINE

UNDERGROUND GAS LINE UNDERGROUND TELECOM LINE

ASPHALT GRIND & OVERLAY

ASPHALT (INCL. AC PLUG)

EXPOSED AGGREGATE CONCRETE COLORIZED PAVEMENT (STAMPED)

KEYNOTE

DETAIL IDENTIFICATION SHEET WHERE DETAIL IS SHOWN

UNDERGROUND ELECTRIC LINE

STORM DRAIN

FLOW LINE

FENCE

WATER

DEMOLISH MATERIAL

CONFORM GRIND

CONCRETE

IRON PIPE CENTERLINE MONUMENT

TELECOMMUNICATION MANHOLE

SURVEY MONUMENT

Drawing Number:

OBTAIN AND PAY FOR ALL CONSTRUCTION PERMITS REQUIRED BY THE TOWN OF ROSS DEPARTMENT OF PUBLIC WORKS, COUNTY OF MARIN DEPARTMENT OF PUBLIC WORKS (SUCH AS ENCROACHMENT, GRADING, DEMOLITION ETC.) PRIOR TO COMMENCEMENT OF WORK. A TRAFFIC CONTROL PLAN MUST BE SUBMITTED FOR APPROVAL PRIOR TO BEGINNING ANY WORK WITHIN THE PUBLIC RIGHT-OF-WAY.

TEMPORARY STOCKPILES SHALL NOT BE LOCATED WITHIN CREEK SETBACK AREAS. PROTECTED VEGETATION/TREE AREAS OR WITHIN 10-FEET OF AN ADJACÉNT RESIDENTIAL PROPERTY LINE. STOCKPILES TALLER THAN ALL STORM DRAIN SHOWN "S.D." SHALL BE R.C.P. UNLESS OTHERWISE PROPERTY LINE.

IF CONTAMINATED MATERIAL IS ENCOUNTERED DURING CONSTRUCTION WORK MUST STOP UNTIL A WORK PLAN HAS BEEN APPROVED IN WRITING BY THE TOWN OF ROSS, COUNTY OF MARIN AND THE SAN FRANCISCO BAY REGIONAL WATER QUALITY CONTROL BOARD. HAZARDOUS MATERIAL SHALL BE REMOVED AND DISPOSED OF ACCORDING TO THE REQUIREMENTS OF THE TOWN OF ROSS AND COUNTY OF MARIN.

SPOILS SHALL BE REMOVED AS THEY ARE GENERATED OR DISPOSED OF ON SITE. EXCESS/UNSUITABLE MATERIAL DISPOSED OF OFFSITE SHALL BE AT A LOCATION APPROVED BY THE TOWN OF ROSS. CONTAIN AND SECURELY PROTECT STOCKPILED BACKFILL AND WASTE MATERIAL FROM WIND AND RAIN AT ALL TIMES UNLESS ACTIVELY BEING USED. DO NOT BLOCK STORM WATER FLOWS.

IN ACCORDANCE WITH GENERALLY ACCEPTED CONSTRUCTION PRACTICES, THE CONSTRUCTION CONTRACTOR WILL BE REQUIRED TO ASSUME SOLE AND COMPLETE RESPONSIBILITY FOR JOB SITE CONDITIONS DURING THE COURSE OF CONSTRUCTION OF THE PROJECT, INCLUDING SAFETY OF ALL PERSONS AND PROPERTY. THIS REQUIREMENT SHALL BE MADE TO APPLY CONTINUOUSLY AND NOT BE LIMITED TO NORMAL WORKING HOURS. THE CONSTRUCTION CONTRACTOR FURTHER AGREES TO HOLD HARMLESS, INDEMNIFY AND DEFEND THE DESIGN PROFESSIONAL, THE OWNER AND THEIR CONSULTANTS, THE TOWN OF ROSS, THE COUNTY OF MARIN, AND EACH OF THEIR OFFICERS, EMPLOYEES, AND AGENTS FROM ANY AND ALL LIABILITY, REAL OR ALLEGED, IN CONNECTION WITH THE PERFORMANCE OF WORK ON THIS PROJECT, EXCEPTING LIABILITY ARISING FROM THE SOLE NEGLIGENCE OF THE DESIGN PROFESSIONAL.

THE LOCATIONS OF UNDERGROUND OBSTRUCTIONS SHOWN ON THESE DRAWINGS ARE APPROXIMATE ONLY AND SHOULD NOT BE TAKEN AS FINAL OR ALL INCLUSIVE. THE CONTRACTOR IS CAUTIONED THAT THESE DRAWINGS MAY NOT INCLUDE ALL EXISTING UTILITIES INCLUDING SEWERS AND STORM DRAINS, AND THAT THE OWNER, THE TOWN OF ROSS, NOTIFY THE CITY ENGINEER A MINIMUM OF 48-HOURS PRIOR TO THE DAY THE COUNTY OF MARIN AND THE DESIGN PROFESSIONAL ASSUME NO OF LAYOUT OF THE PROPOSED SIGNING AND STRIPING. RESPONSIBILITY FOR OBSTRUCTIONS WHICH MAY BE ENCOUNTERED.

EXPOSE ALL EXISTING UTILITIES INCLUDING SEWERS AND STORM DRAINS PRIOR TO ANY TRENCHING TO ALLOW THE DESIGN PROFESSIONAL TO VERIFY THE GRADE AND ALIGNMENT OF THE UTILITIES, AND TO VERIFY DESIGN ASSUMPTIONS AND EXACT FIELD LOCATIONS. EXISTING UTILITIES MAY REQUIRE RELOCATION AND/OR PROPOSED IMPROVEMENTS MAY REQUIRE GRADE OR ALIGNMENT REVISION DUE TO FIELD REMOVE EXISTING STRIPING AND MARKING BY GRINDING.

PROPERLY MUFFLE EQUIPMENT AND LIMIT CONSTRUCTION HOURS TO 7:00 AM TO 6:00 PM MONDAY THROUGH FRIDAY, AND 9:00 AM TO 6:00 PM ON SATURDAY. EXCLUDING HOLIDAYS. THIS RESTRICTION INCLUDES THE STARTUP OF MOTOR VEHICLES AND OTHER HEAVY EQUIPMENT.

REPAIR DAMAGE OR DETERIORATION OCCURRING TO EXISTING PUBLIC IMPROVEMENTS AS A DIRECT RESULT OF CONSTRUCTION ACTIVITY (GRADING, ROAD CONSTRUCTION, UTILITY INSTALLATION, ETC.). REPAIR MAY REQUIRE PATCHING, SEALING OR OVERLAYING AFFECTED AREAS AS APPROPRIATE TO RETURN THE ROADS TO AT LEAST AS GOOD A CONDITION AS THEY WERE PRIOR TO CONSTRUCTION. IF THE CONTRACTOR ALL COSTS AND OVERHEAD INCURRED.

PROVIDE AS-BUILT DRAWINGS TO THE TOWN OF ROSS UPON COMPLETION OF PROJECT AND PRIOR TO FINAL ACCEPTANCE.

ADA COMPLIANCE: COMPLY WITH THE REQUIREMENTS OF THE AMERICAN WITH DISABILITIES ACT (ADA) WHILE WORKING IN THE PUBLIC RIGHT-OF-WAY. IF CONSTRUCTION CONTRACTOR'S WORK IN THE PUBLIC RIGHT-OF-WAY WILL AFFECT PEDESTRIAN ACCESS, THE CONSTRUCTION CONTRACTOR IS REQUIRED TO PROVIDE A PROPERLY SIGNED ACCESSIBLE NOT BE LIMITED TO NORMAL WORKING HOURS.

IN THE EVENT THAT ANY REMAINS OF PREHISTORIC OR HISTORIC HUMAN ACTIVITIES ARE ENCOUNTERED DURING PROJECT-RELATED ACTIVITIES, ALL MEASURED DISTANCES ARE IN GRID FEET AND DECIMALS THEREOF WORK IN THE IMMEDIATE VICINITY OF THE FINDS SHALL HALT AND THE MULTIPLY BY 1.00003020 TO APPROXIMATE GROUND DISTANCES. CONTRACTOR SHALL IMMEDIATELY NOTIFY THE PROJECT SUPERINTENDENT AND THE PROJECT INSPECTOR. WORK SHALL NOT RESUME UNTIL A QUALIFIED ARCHAEOLOGIST OR HISTORIC ARCHAEOLOGIST, AS TEMPORARY BENCHMARK: MAG NAIL AND WASHER IN SIDEWALK STAMPED APPROPRIATE, APPROVED BY THE TOWN OF ROSS AND/OR COUNTY OF "LA STEVENS CONTROL", LOCATION SHOWN HEREON. MARIN, HAS EVALUATED THE SITUATION AND MADE RECOMMENDATIONS FOR ELEVATION (NAVD88): 32.64' TREATMENT OF THE RESOURCE, AND WHOSE RECOMMENDATIONS ARE CARRIED OUT. IF HUMAN BURIAL REMAINS ARE ENCOUNTERED, THE CONTRACTOR MUST ALSO CONTACT THE MARIN COUNTY CORONER.

GRADING NOTES

NO GRADING, CLEARING OR GRUBBING SHALL BE PERFORMED PRIOR TO ISSUANCE OF AN ENCROACHMENT PERMIT BY THE TOWN OF ROSS DEPARTMENT OF PUBLIC WORKS, COUNTY OF MARIN DEPARTMENT OF PUBLIC WORKS AND CALTRANS.

PROVIDE DUST CONTROL THROUGHOUT THE DURATION OF THE CONSTRUCTION PROJECT TO MINIMIZE AIRBORNE POLLUTANTS.

PERFORM GRADING IN ACCORDANCE WITH CHAPTER 18 AND APPENDIX J OF THE CALIFORNIA BUILDING CODE (THE VERSION IN EFFECT AS ADOPTED BY CITY AT THE TIME OF PERMIT ISSUANCE), UNDER THE OBSERVATION OF THE GEOTECHNICAL ENGINEER AND IN ACCORDANCE WITH THE RECOMMENDATIONS OF THE GEOTECHNICAL REPORT, PREPARED BY MILLER PACIFIC GROUP, INC. DATED SEPTEMBER 2, 2021.

FURNISH AND INSTALL MATERIALS IN ACCORDANCE WITH THE STANDARD DO NOT BLOCK DRAINAGE FROM UPSTREAM PROPERTIES WITH GRADING OR

REMOVE AND DISPOSE OF HAZARDOUS MATERIAL ACCORDING TO THE REQUIREMENTS OF THE TOWN OF ROSS FIRE DEPARTMENT.

DRIP LINES OF TREES OVERHANGING THE PROPERTY LINE SHALL BE AFFORDED THE SAME LEVEL OF PROTECTION AS TREES THAT ARE TO

UTILITY NOTES

2.5-FEET SHALL NOT BE WITHIN 50-FEET OF AN ADJACENT RESIDENTIAL NOTED. RCP STORM DRAIN SHALL BE CLASS IV UNLESS OTHERWISE SHOWN ON THE DRAWINGS. IF PIPE MATERIAL IS CHANGED, THEN, DRAWING REVISIONS MAY BE REQUIRED.

> UTILITY TRENCHING SHALL BE IN ACCORDANCE WITH COUNTY OF MARIN UNIFORM CONSTRUCTION STANDARD 330.

> ALL STORM DRAIN PIPE LENGTHS SHOWN ARE MEASURED HORIZONTALLY FROM CENTER OF STRUCTURES.

> STORM DRAIN SYSTEM SHALL BE KEPT FREE OF DIRT AND DEBRIS DURING ALL PHASES OF CONSTRUCTION. IT IS NOT ALLOWED TO WASH DIRT/DEBRIS DOWNSTREAM IN PIPES.

CONTACT MARIN MUNICIPAL WATER DISTRICT ENGINEERING SERVICES DEPARTMENT AT 415.945.1530 TO INITIATE RELOCATION OF EXISTING WATER METER (REFER TO PLAN)

STRIPING AND SIGNING NOTES

REPLACE STRIPING THAT IS REMOVED TO FACILITATE THE PROPOSED IMPROVEMENTS.

INSTALL STRIPING AND SIGNING IN ACCORDANCE WITH CALIFORNIA MUTCD REQUIREMENTS. MATERIALS SHALL BE FURNISHED BY THE

STRIPING, PAVEMENT MARKING AND SIGNING SHALL CONFORM TO THE CALTRANS STANDARD PLANS AND THE CALIFORNIA MUTCD (CURRENT EDITIONS).

ACCEPT RESPONSIBILITY FOR LAYOUT AND CAT TRACKING OF ALL PROPOSED STRIPING AND MARKING. PERFORM CAT TRACKING A MINIMUM OF 48-HOURS PRIOR TO PROPOSED STRIPING AND MARKING TO ALLOW THE CITY ENGINEER TIME FOR REVIEW AND APPROVAL

INSTALL SIGNING AND STRIPING CONCURRENTLY.

SURVEY NOTES

TREE TRUNK DIAMETERS ARE REFLECTED GRAPHICALLY AND WERE MEASURED AT CHEST HEIGHT (±48 INCHES). DRIPLINE DIAMETERS AND TREE SPECIES ARE APPROXIMATE ONLY. CONSULT A CERTIFIED TREE ARBORIST WHEN IT IS NECESSARY TO ACCURATELY DETERMINE PERTINENT TREE INFORMATION.

DOES NOT ACT IN A TIMELY MANNER, THE CITY MAY, AT ITS PRESERVE AND PERPETUATE EXISTING SURVEY MONUMENTATION WHICH DISCRETION PERFORM THE CORRECTION AND CHARGE THE CONTRACTOR FOR WILL BE DISTURBED OR REMOVED TO FACILITATE THE PROPOSED IMPROVEMENTS. IF WORK WILL BE CONDUCTED IN AN AREA WHICH RESULTS IN THE DISTURBANCE OF MONUMENTATION, RETAIN THE SERVICES OF A LICENSED LAND SURVEYOR TO LOCATE SAID MONUMENTATION PRIOR TO DISTURBANCE. ADDITIONALLY, RETAIN THE SERVICES OF A LICENSED LAND SURVEYOR TO RE-ESTABLISH MONUMENTATION WHICH HAS BEEN DISTURBED AS A RESULT OF PROJECT CONSTRUCTION AND TO FILE THE APPROPRIATE DOCUMENTATION, PURSUANT TO BUSINESS AND PROFESSIONS CODE SECTION 8771, WITH THE MARIN COUNTY RECORDER ONCE CONSTRUCTION IS COMPLETE.

ROUTE OF TRAVEL. THIS REQUIREMENT SHALL APPLY CONTINUOUSLY AND TOPOGRAPHIC INFORMATION SHOWN HEREON WAS MAPPED BY FOLLOWING FIELD SURVEYS BY L.A. STEVENS & ASSOCIATES, INC. FROM MAY 2020 THROUGH NOVEMBER 2020 PROVIDED TO BKF BY THE TOWN OF ROSS.

BENCHMARK: ELEVATION ESTABLISHED BY GPS RELATIVE POSITIONING FROM NATIONAL GEODETIC SURVEY (NGS) CONTINUOUSLY OPERATING REFERENCE STATIONS (CORS). STATIONS USED WERE OHLN, P181, P198, P261, AND TIBB.

BASIS OF BEARING: THE BASIS OF BEARINGS OF THIS SURVEY IS S31°46'44"W, ROTATED CLOCKWISE 01°38'25" FROM 2008 RS 150 BETWEEN FOUND 2"X2" HUB AND FOUND 2" BRASS DISK STAMPED "RC-1".

EROSION AND SEDIMENT CONTROL NOTES

EROSION AND SEDIMENT CONTROL MEASURES SHALL BE USED TO ENSURE THAT WATER ENTERING THE STORM DRAIN SYSTEM FROM THE CONSTRUCTION SITE IS OF EQUIVALENT QUALITY AND CHARACTER AS THE WATER ABOVE THE SITE.

KEEP THE WORK SITE, STAGING AREAS AND OTHER AREAS USED BY THE CONTRACTOR IN A NEAT AND CLEAN CONDITION, AND FREE FROM ANY ACCUMULATION OF TRASH. DISPOSE OF ALL TRASH, RUBBISH AND WASTE MATERIALS OF ANY KIND GENERATED BY THE CONTRACTOR SUBCONTRACTOR OR ANY COMPANY HIRED BY THE CONTRACTOR ON A DAILY BASIS. KEEP HAUL ROADS FREE FROM DIRT, RUBBISH, AND UNNECESSARY OBSTRUCTIONS RESULTING FROM SITE OPERATION. DISPOSE OF ALL TRASH, RUBBISH AND DEBRIS MATERIALS IN A COVERED WASTE RECEPTACLE OR HAUL OFF SITE, IN ACCORDANCE WITH LOCAL CODES AND ORDINANCES GOVERNING LOCATIONS AND METHODS OF DISPOSAL, AND IN CONFORMANCE WITH ALL APPLICABLE LAWS AND REGULATIONS. COVER WASTE RECEPTACLES AT THE END OF EVERY DAY AND DURING RAIN

MAINTAIN A CLEAN CONSTRUCTION SITE TO PREVENT THE INTRODUCTION OF FOREIGN MATERIALS INTO THE STORM WATER CONVEYANCE SYSTEM. ACTIVITY DURING CONSTRUCTION WHICH RESULTS IN THE DISCHARGE OF POLLUTANTS TO THE STORM WATER CONVEYANCE SYSTEM IS IN VIOLATION OF THE TOWN OF ROSS CODE OF ORDINANCES AND THE SAN FRANCISCO BAY REGIONAL WATER QUALITY CONTROL BOARD'S REGULATIONS.

PROVIDE CONTAINMENT FOR SANITATION FACILITIES (E.G., PORTABLE TOILETS) TO PREVENT DISCHARGES OF POLLUTANTS TO THE STORM WATER DRAINAGE SYSTEM, ROADS OR RECEIVING WATERS. SANITATION FACILITIES MUST BE MAINTAINED PERIODICALLY BY A LICENSED SERVICE COMPANY TO KEEP THEM IN GOOD WORKING ORDER AND PREVENT OVERFLOWS. PORTABLE TOILETS ARE REQUIRED TO HAVE SECONDARY CONTAINMENT.

EQUIPMENT AND MATERIALS NECESSARY FOR CONTROL OF SPILLS SHALL BE AVAILABLE ON SITE AT ALL TIMES. SPILLS AND LEAKS SHALL BE STOPPED AND THE MATERIAL CLEANED UP IMMEDIATELY AND DISPOSED OF PROPERLY. USE PROPER BEST MANAGEMENT PRACTICES (BMPS) TO PREVENT OIL, GREASE, OR FUEL FROM LEAKING ON THE GROUND, INTO THE STORM DRAINS OR SURFACE WATERS.

CONTAIN CONCRETE WASHOUT AREAS AND SIMILAR AREAS THAT MAY CONTAIN POLLUTANTS TO PREVENT DISCHARGE INTO THE UNDERLYING SOIL OR ONTO THE SURROUNDING AREAS.

ESTABLISH AND MAINTAIN EFFECTIVE SITE PERIMETER CONTROLS AND STABILIZE ALL CONSTRUCTION ENTRANCES AND EXITS TO SUFFICIENTLY CONTROL EROSION AND SEDIMENT DISCHARGES AND TRACKED MATERIALS FROM LEAVING THE SITE. AT A MINIMUM DAILY AND PRIOR TO ANY RAIN EVENT, THE CONTRACTOR SHALL REMOVE ANY SEDIMENT OR OTHER CONSTRUCTION ACTIVITY RELATED MATERIALS THAT ARE DEPOSITED ON THE ROADS (BY VACUUMING OR SWEEPING).

PLACE EQUIPMENT OR VEHICLES WHICH ARE BEING FUELED, MAINTAINED AND STORED, IN A DESIGNATED AREA FITTED WITH APPROPRIATE BMPS.

AT A MINIMUM, ALL BMPS SHALL BE INSPECTED EACH WORKING DAY AND BEFORE ALL RAIN EVENTS. BMPS THAT REQUIRE MAINTENANCE OR REPLACEMENT TO FUNCTION PROPERLY SHALL BE COMPLETED BEFORE THE NEXT FORECASTED RAIN, OR WITHIN THE NEXT THREE (3) WORKING DAYS IF NO RAIN IS PREDICTED. MAINTENANCE INCLUDES REMOVAL OF ACCUMULATED SEDIMENT AND TRASH.

ALL EROSION AND SEDIMENT CONTROL MEASURES SHALL BE REMOVED WHEN THEY HAVE SERVED THEIR PURPOSE SO AS NOT TO BLOCK OR IMPEDE STORM FLOW OR DRAINAGE.

ALL EROSION AND SEDIMENT CONTROL MEASURES SHALL BE REPAIRED OR REPLACED WHEN THEY ARE NO LONGER FUNCTIONING PER BEST MANAGEMENT PRACTICES.

THE CONTRACTOR SHALL HAVE EROSION AND SEDIMENT CONTROL MEASURES ON SITE ADEQUATE TO PROTECT THE ENTIRE SITE SUCH THAT IT IS IMMEDIATELY AVAILABLE IN THE EVENT OF A STORM.

TRASH OR MATERIALS DEPOSITED OR TRACKED INTO THE PUBLIC RIGHT-OF-WAY SHALL BE REMOVED DAILY.

K REGIST

Drawina Number:

210182-10_IMPR.dwa

NOTES

1. REFER TO THE PROJECT GEOTECHNICAL REPORT FOR ESTIMATED EXISTING PAVEMENT SECTION.

THE PROPOSED BACK OF SIDEWALK 2. WHEN THE FINISHED GRADE OF THE PROPOSED BACK OF SIDEWALK


OR PATHWAY IS 2-INCHES OR GREATER ABOVE THE EXISTING GRADE, INSTALL 1-FOOT WIDE SHOULDER BEFORE GRADING A MAXIMUM 2:1 SLOPE TO MEET EXISTING GRADE. SHOULDER SHALL BE CLASS II

AGGREGATE BASE.


3. INSTALL A MINIMUM 8-INCH DEEP ASPHALT PLUG WHEN PROPOSED IMPROVEMENTS ARE BEYOND EXISTING EDGE OF PAVEMENT. REFER

4. UNLESS OTHERWISE NOTED, WHERE THE EXISTING ROAD CROSS SLOPE IS LESS THAN 1.5%, PERFORM A VARIABLE GRIND AND OVERLAY AS NECESSARY TO CREATE A MINIMUM 1.5% CROSS SLOPE.


Drawing Number:

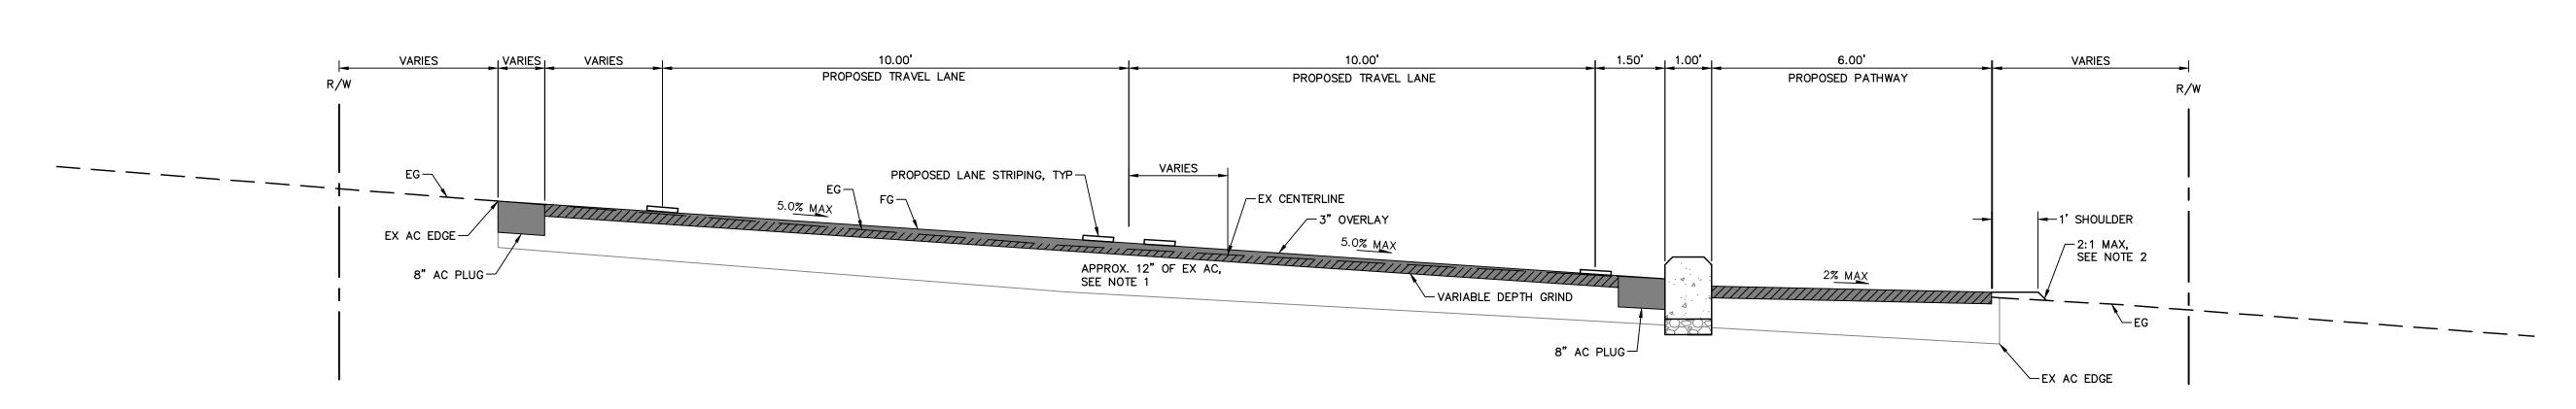

TYPICAL SECTION 1 STA 23+15.83 TO STA 24+45.04

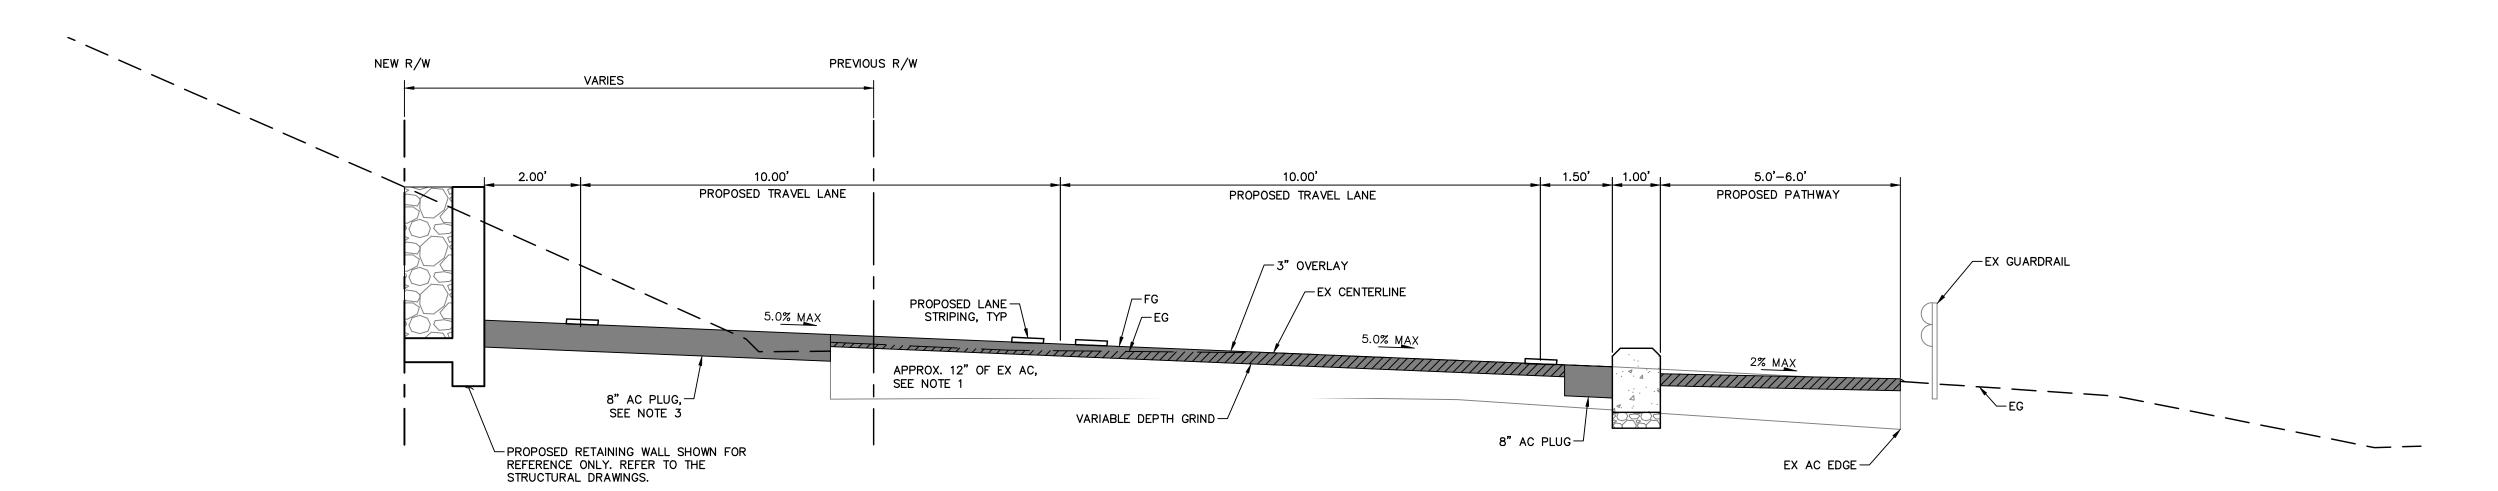

TYPICAL SECTION 2 STA 24+45.04 TO STA 25+45.43

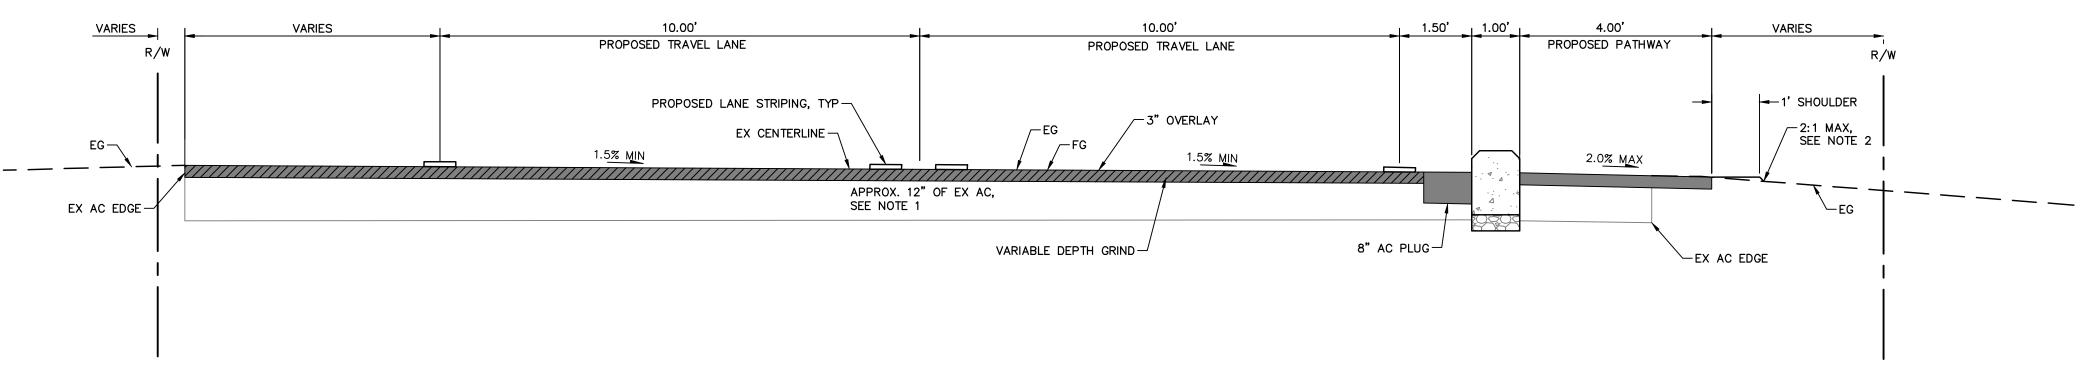


TYPICAL SECTION 3

STA 25+45.43 TO PATHWAY END

COPYRIGHT © 2024 BKF ENGINEERS


210182-10_IMPR.dwg

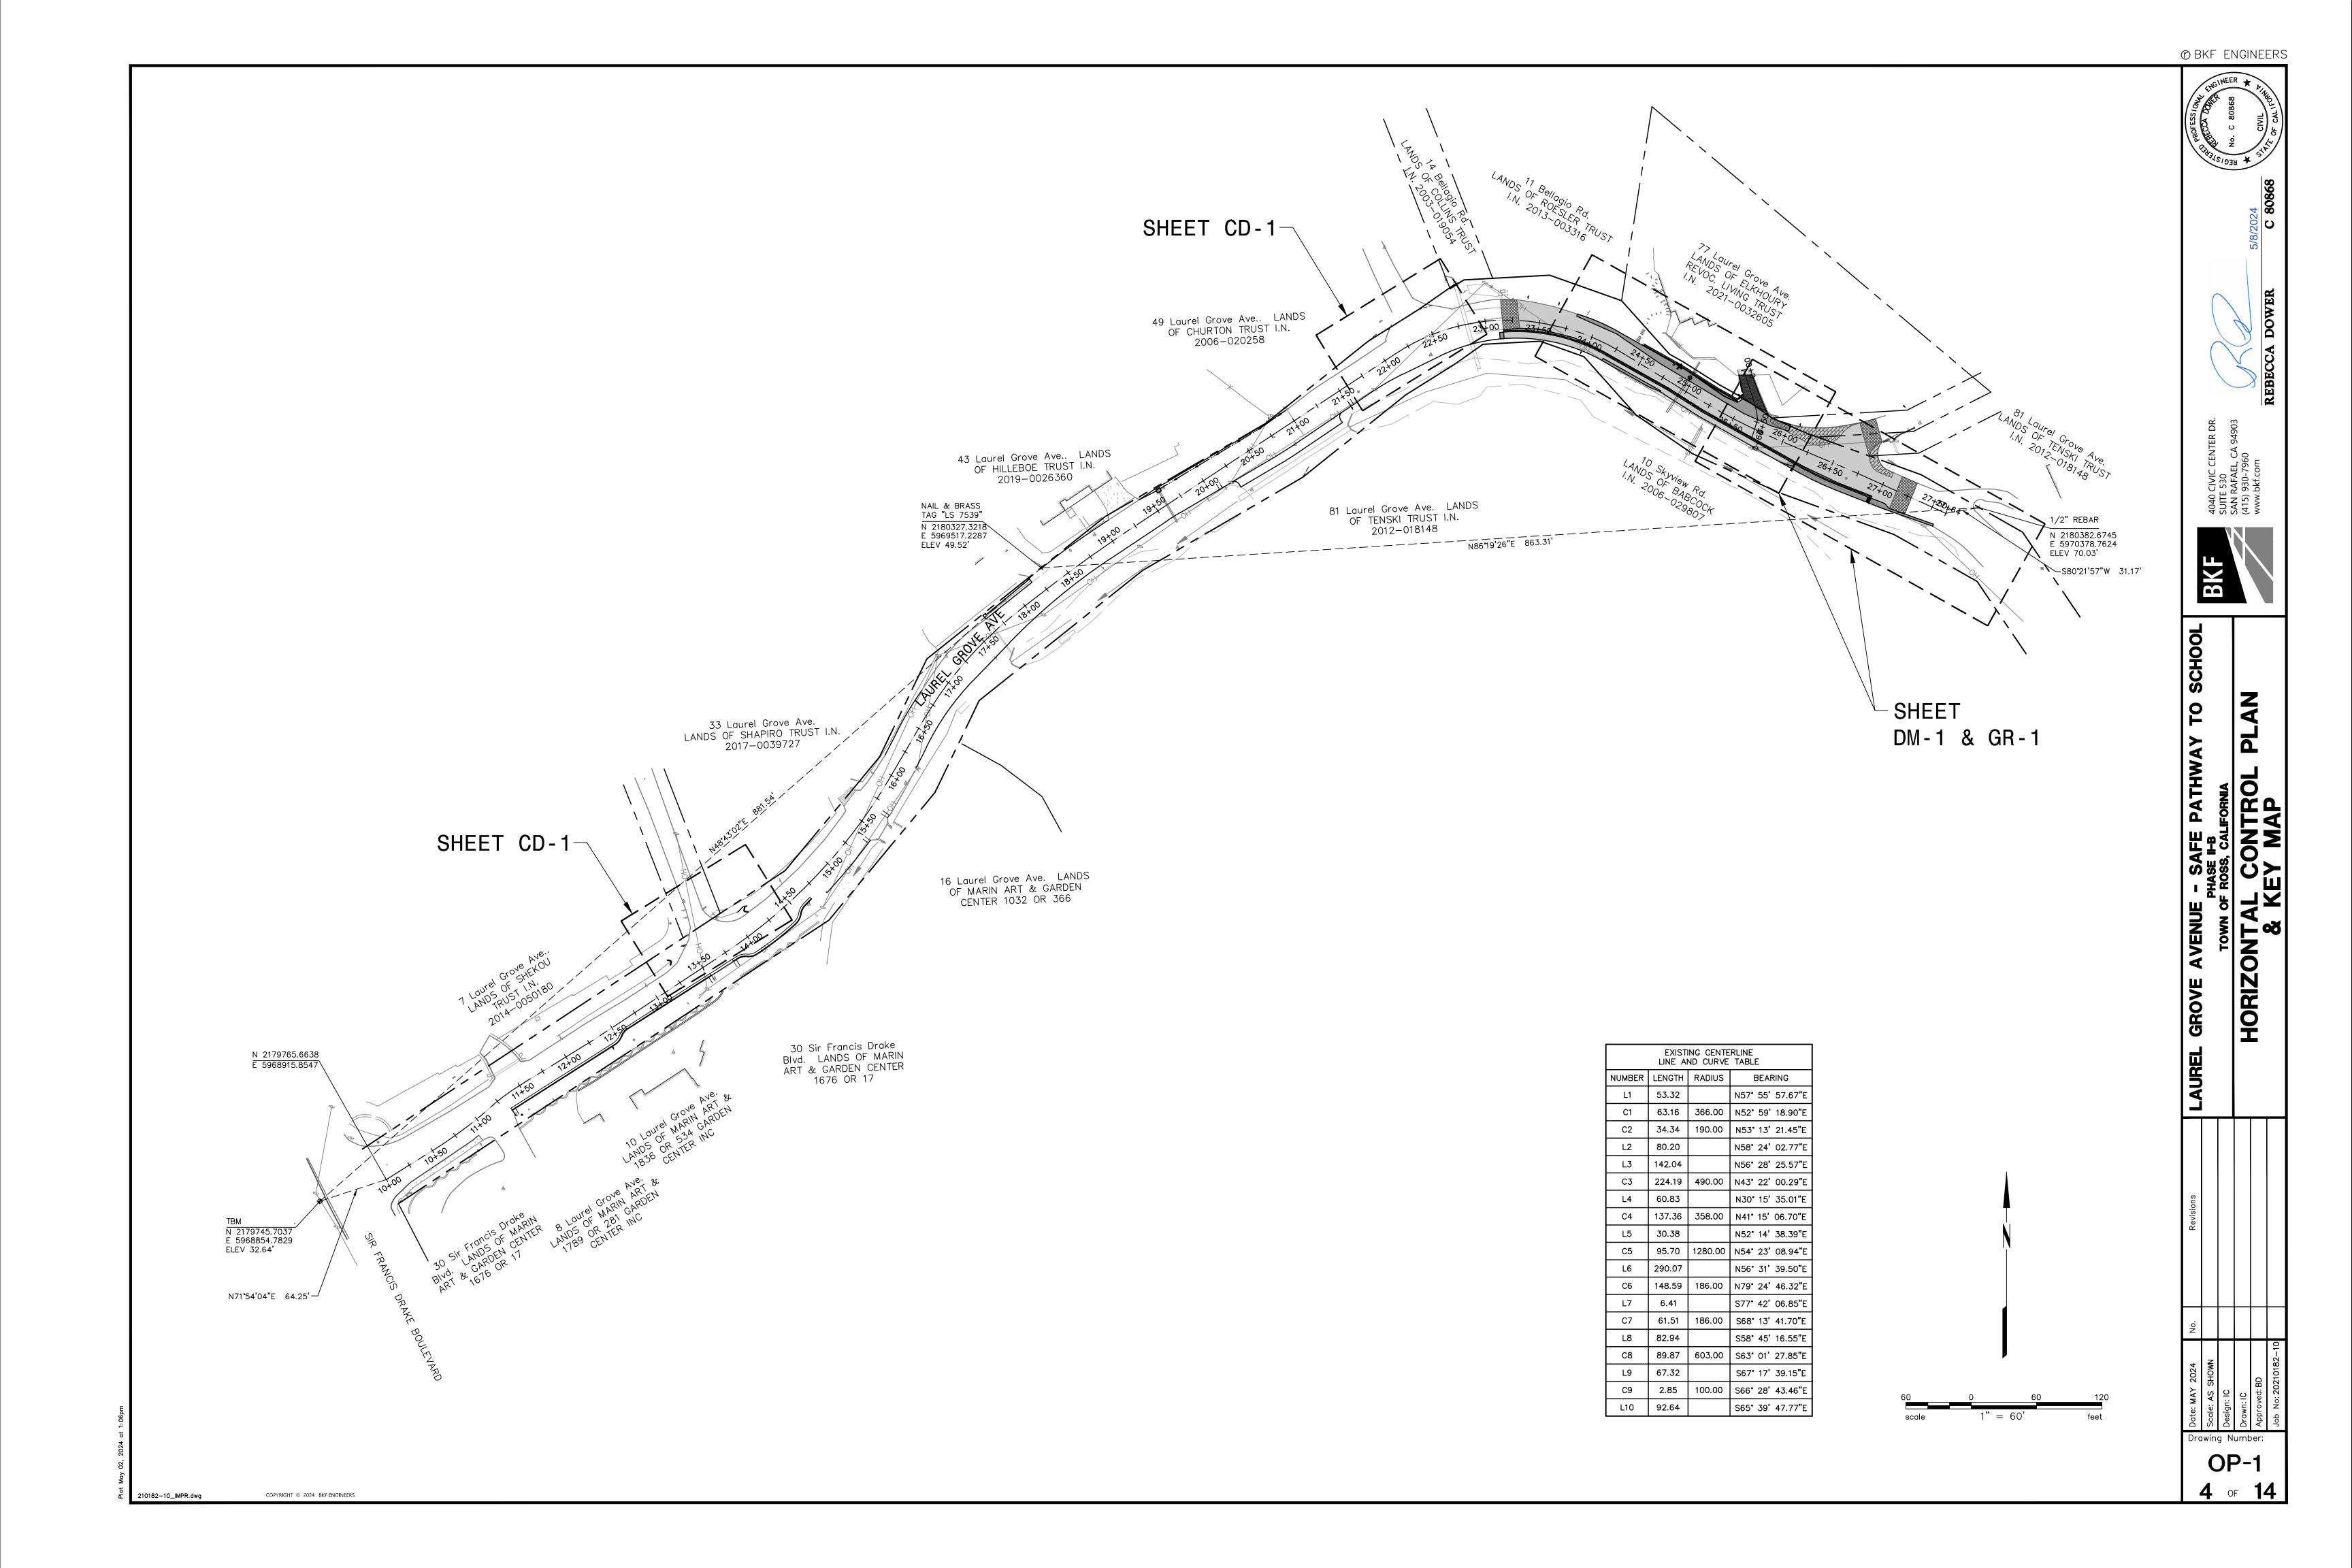


Approximate FL


COPYRIGHT © 2024 BKF ENGINEERS

DM-1

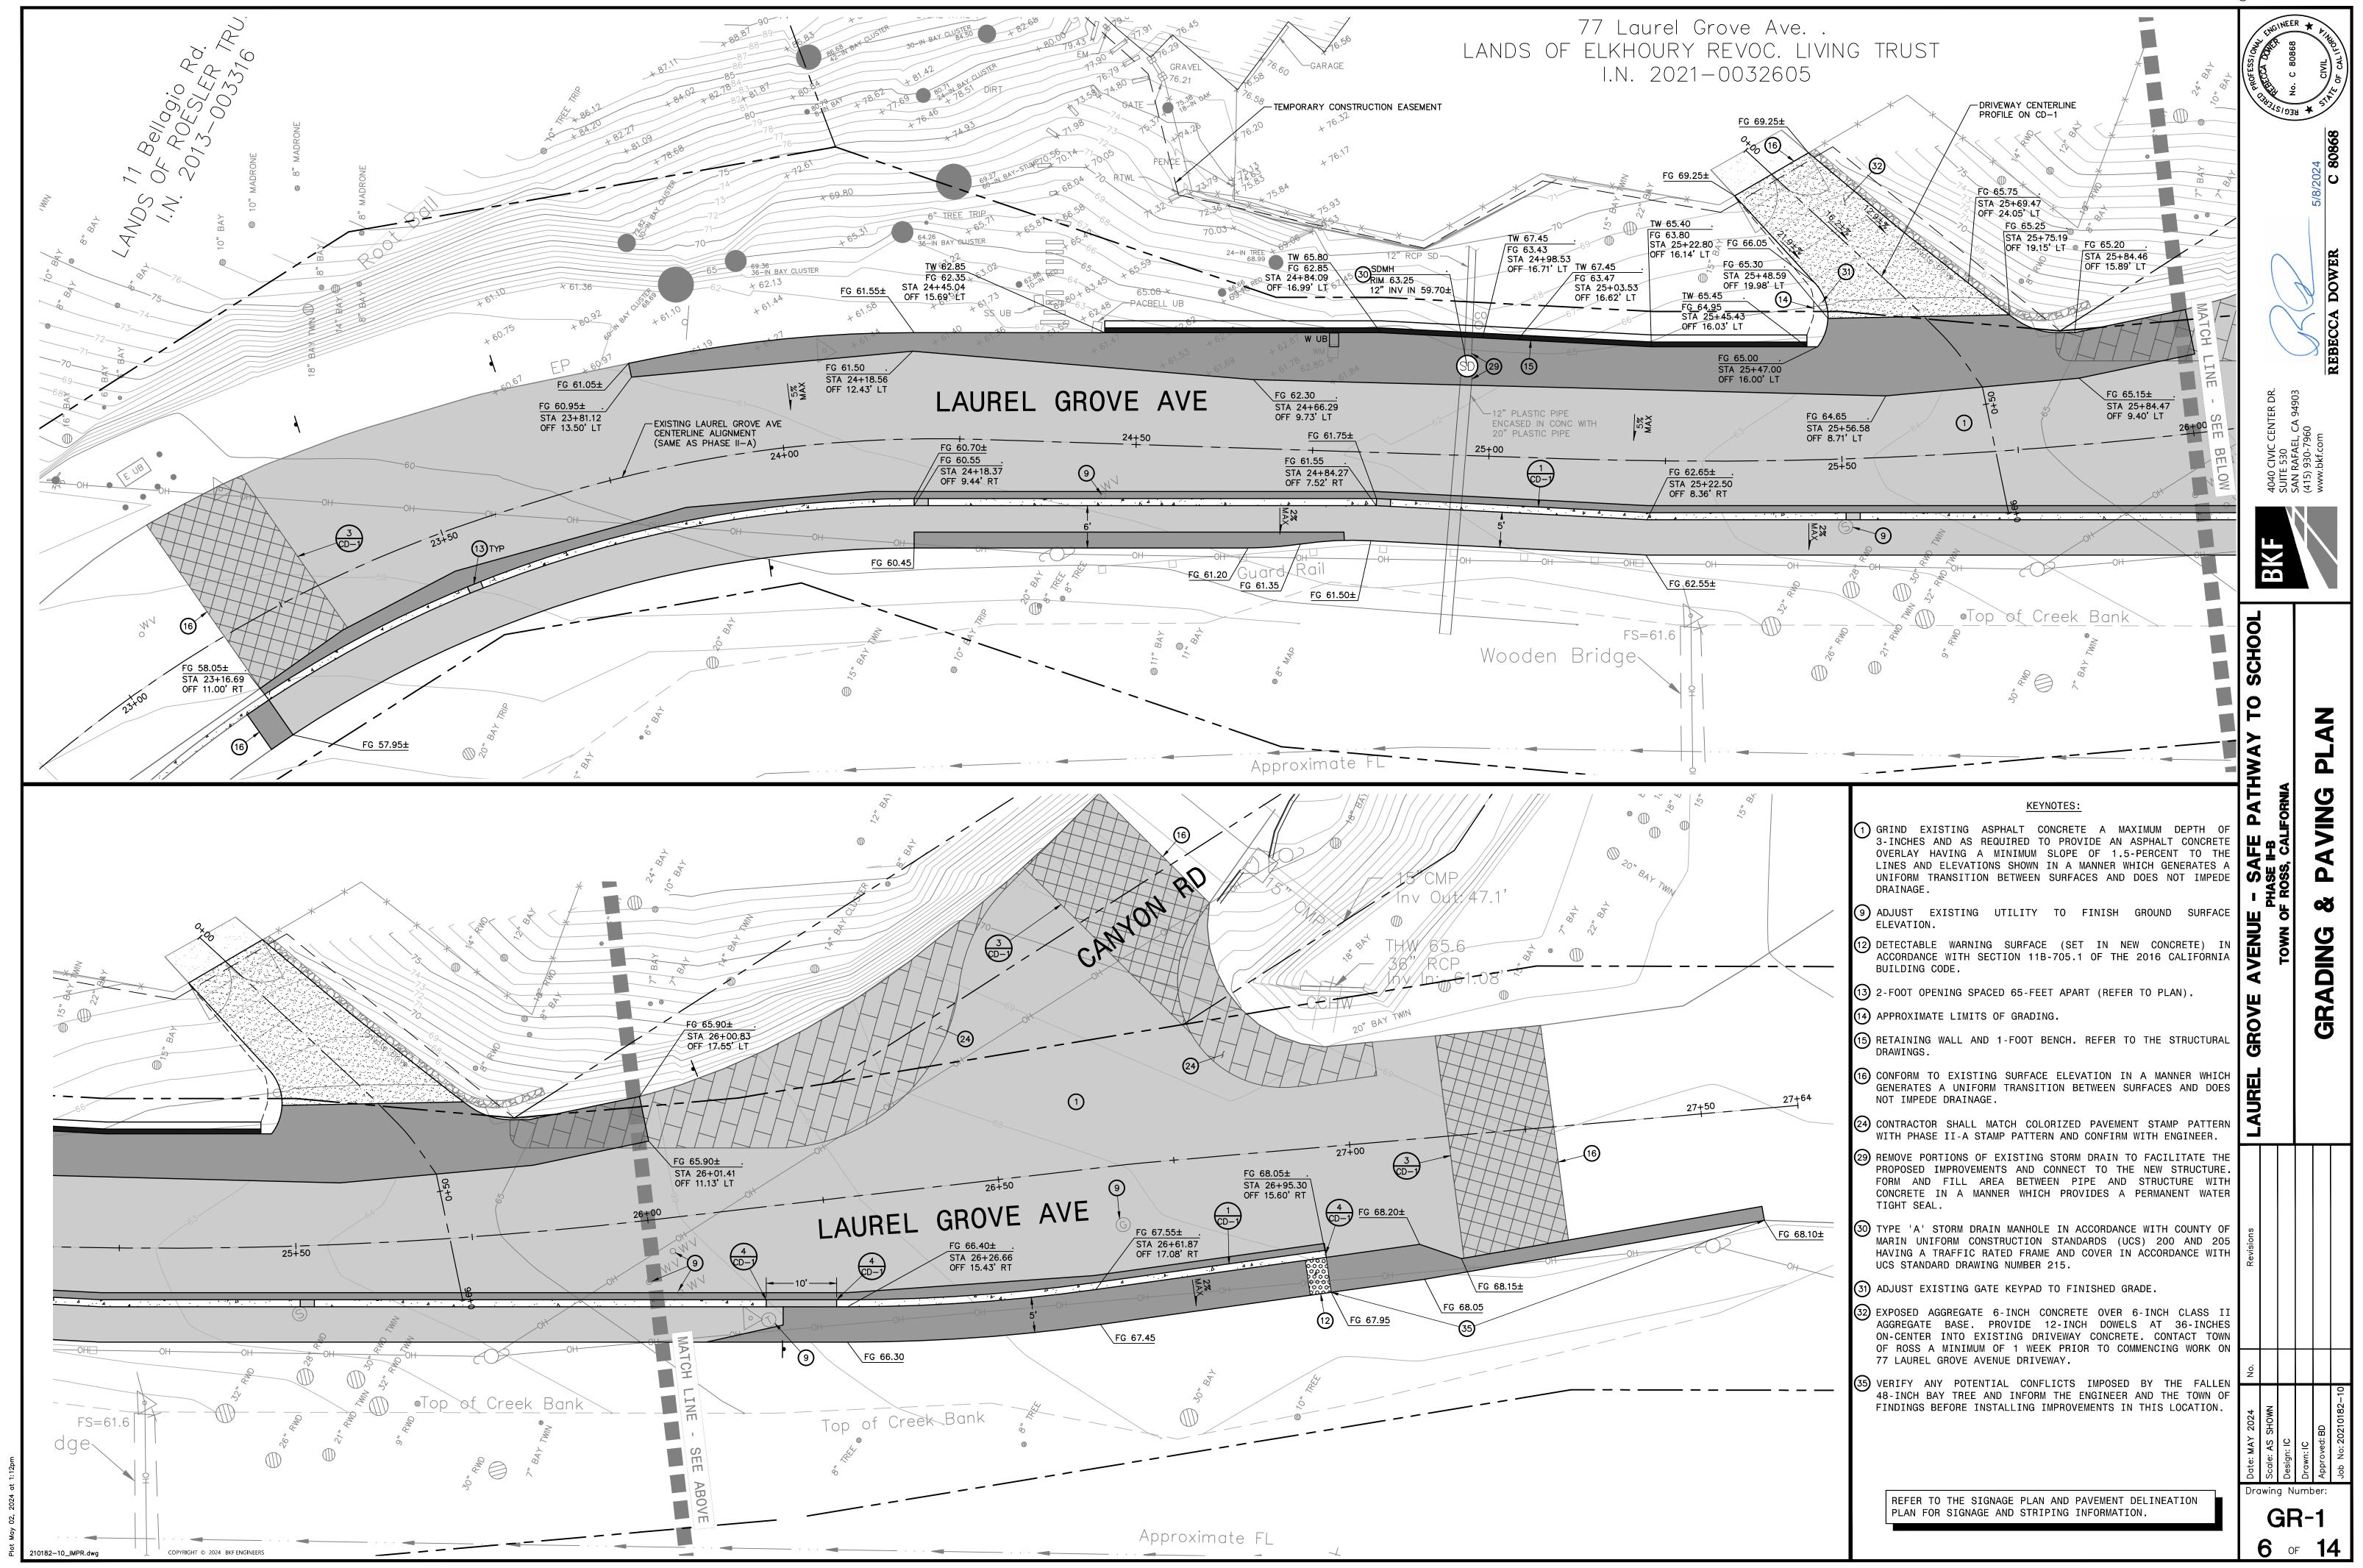

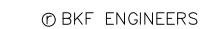



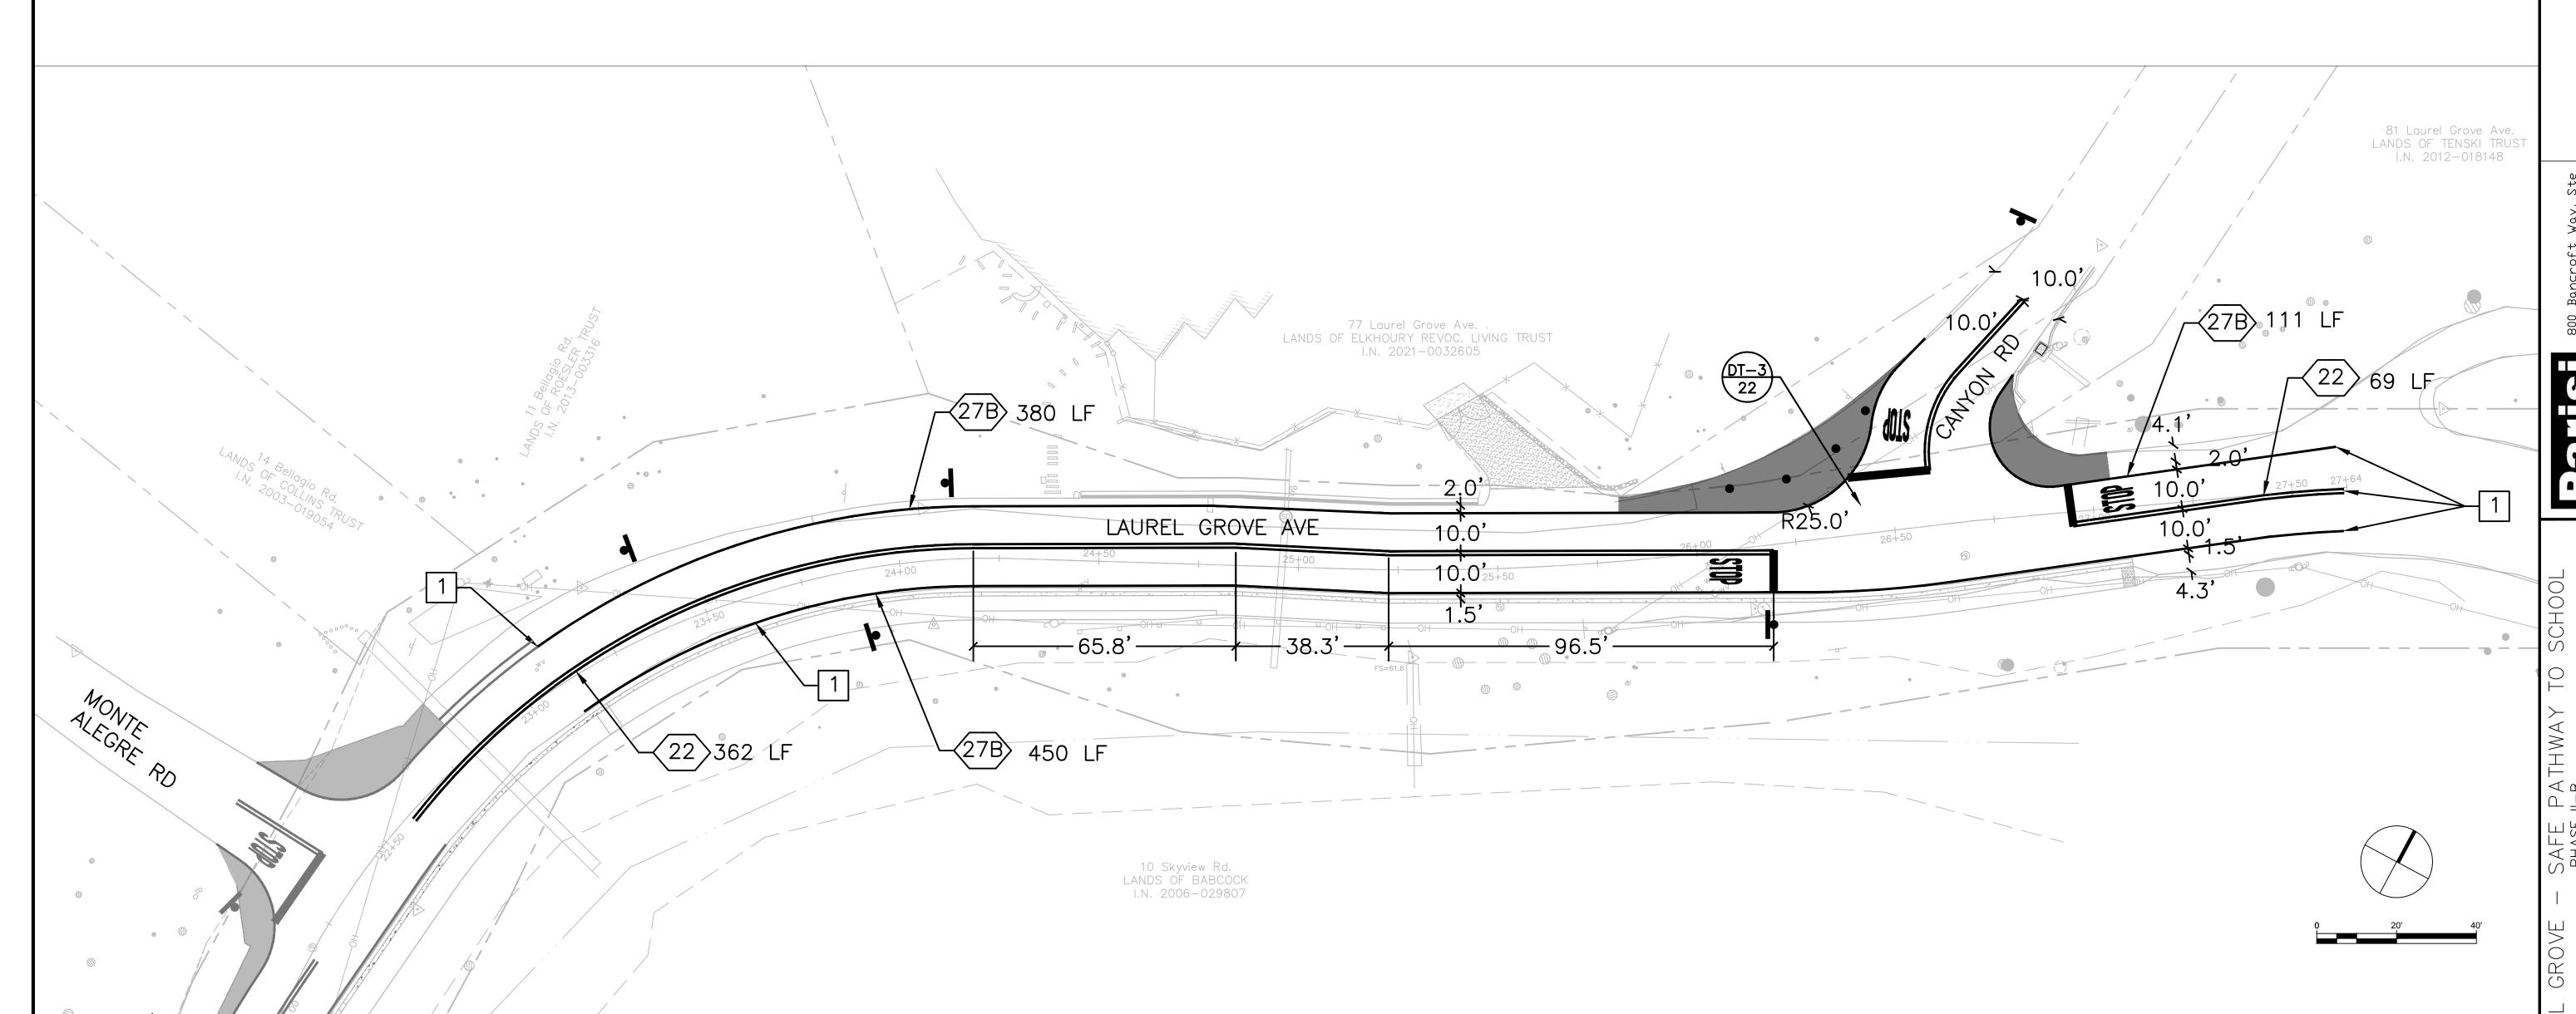

LEGEND & ABBREVIATIONS

(XX)

CALTRANS STRIPING DETAIL

LF LINEAR FEET

TYP TYPICAL

Ross-Laurel Grove - PHASE II-B.dwg COPYRIGHT © 2024 BKF ENGINEERS

CONSTRUCTION NOTES (THIS SHEET ONLY)

TIE PROPOSED STRIPING INTO EXISTING STRIPING TO MAINTAIN MINIMUM 10' TRAVEL LANES.

24 No. Revisions
DWN

awing Number:

PD—1

7 of 14

Plot May 03, 2024 at 11:5



00 Bancroft Way, Ste 03 erkeley, CA 94710 510> 343-6400

Partion CONSULTING


ROVE - SAFE PATHWAY TO SCHC Phase 11-b Laurel grove avenue, ross, ca MENT DELINEATION PLAN

 cale: AS SHOWN

 esign: BA


 pproved: DP

Drawing Number: PD-2 8 of 14

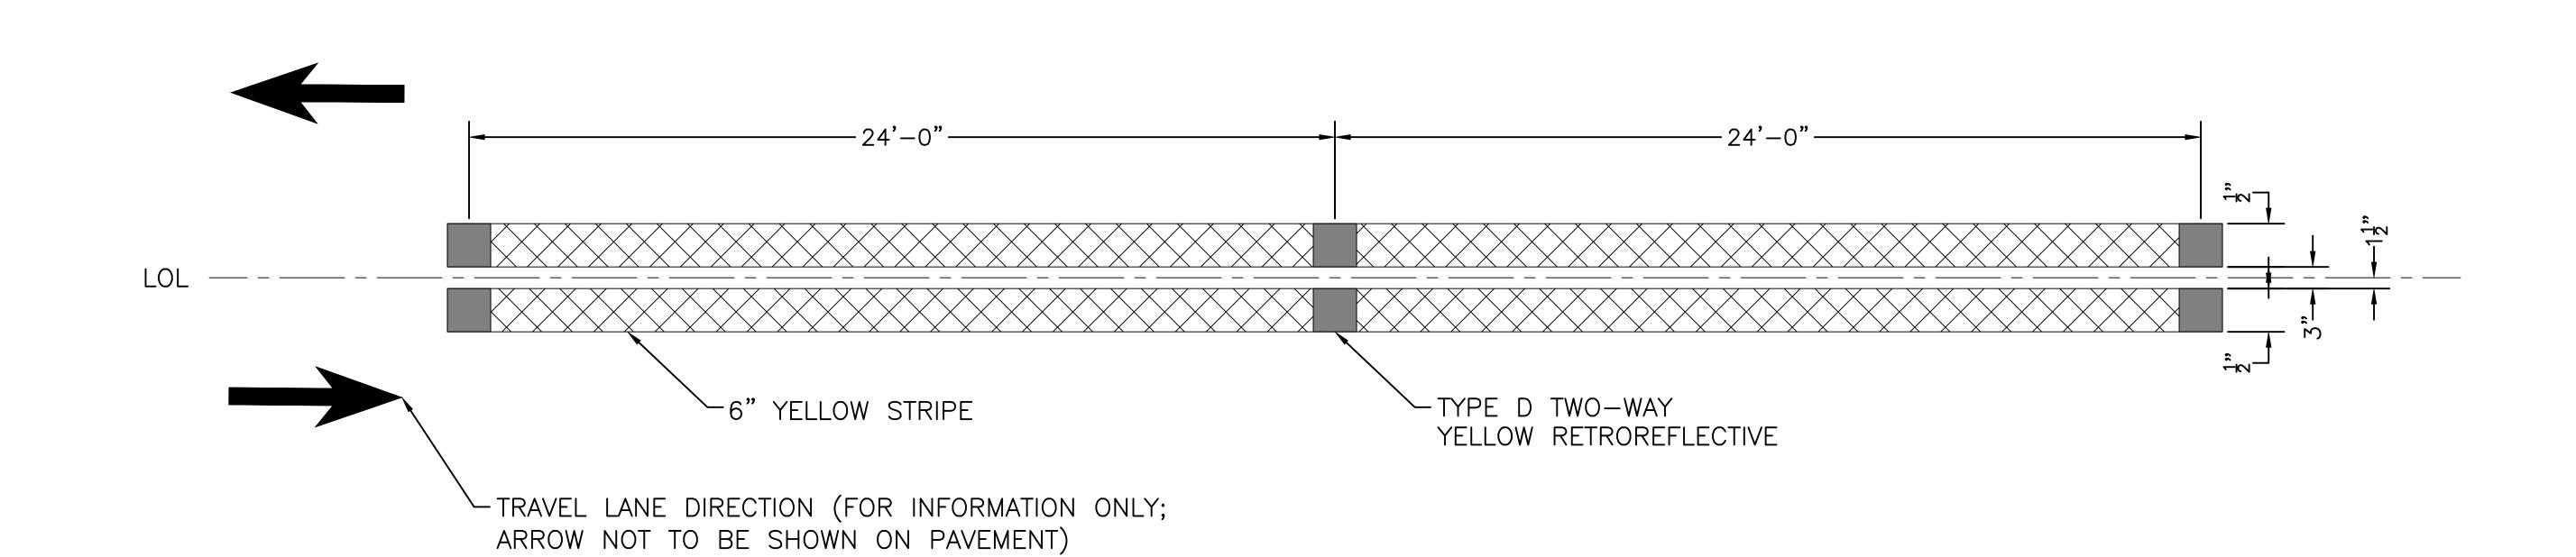

MODIFIED CALTRANS STANDARD DETAIL 22 NO SCALE

Ross-Laurel Grove - PHASE II-B.dwg COPYRIGHT © 2024 BKF ENGINEERS

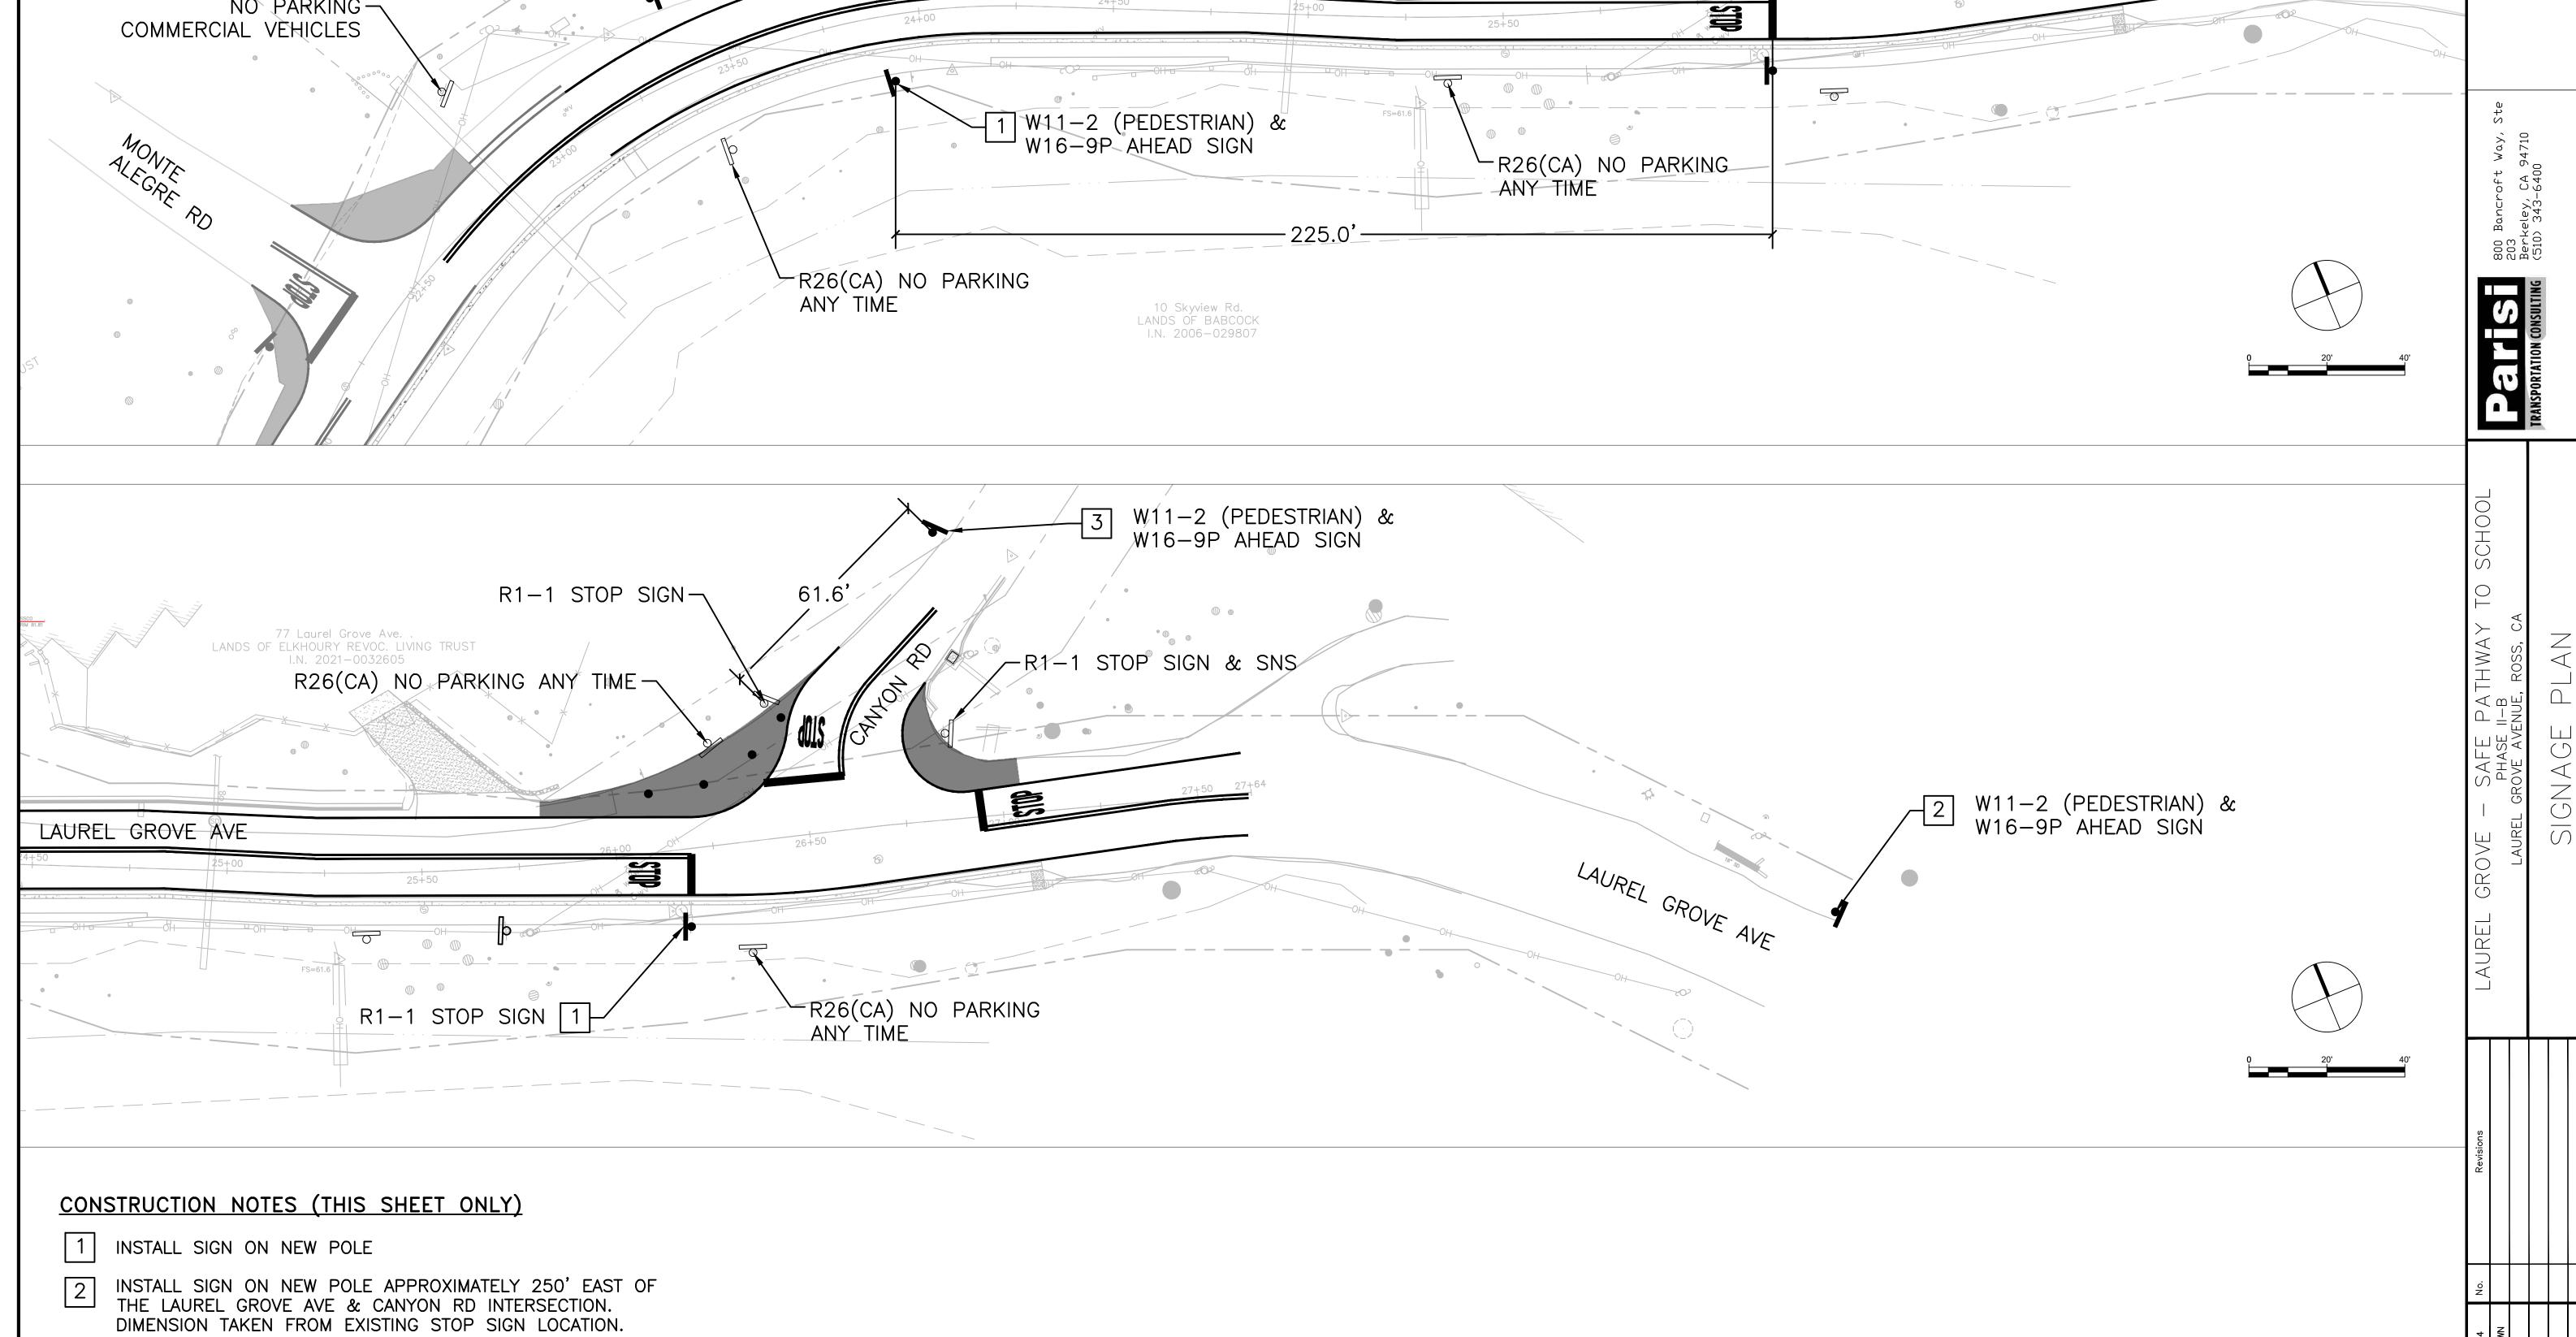

LANDS OF ELKHOURY REVOC. LIVING TRUST I.N. 2021-0032605

1 R26(CA) NO PARKING ANY TIME

LAUREL GROVE AVE

R26(CA) NO PARKING

R26(CA) NO PARKING 1


INSTALL SIGN ON NEW POLE APPROXIMATELY 61' NORTH OF THE LAUREL GROVE AVE & CANYON RD INTERSECTION.

DIMENSION TAKEN FROM EXISTING STOP SIGN LOCATION.

oss-Laurel Grove - PHASE II-B.dwg COPYRIGHT © 2024 BKF ENGINEER

NO PARKING —


ANY TIME

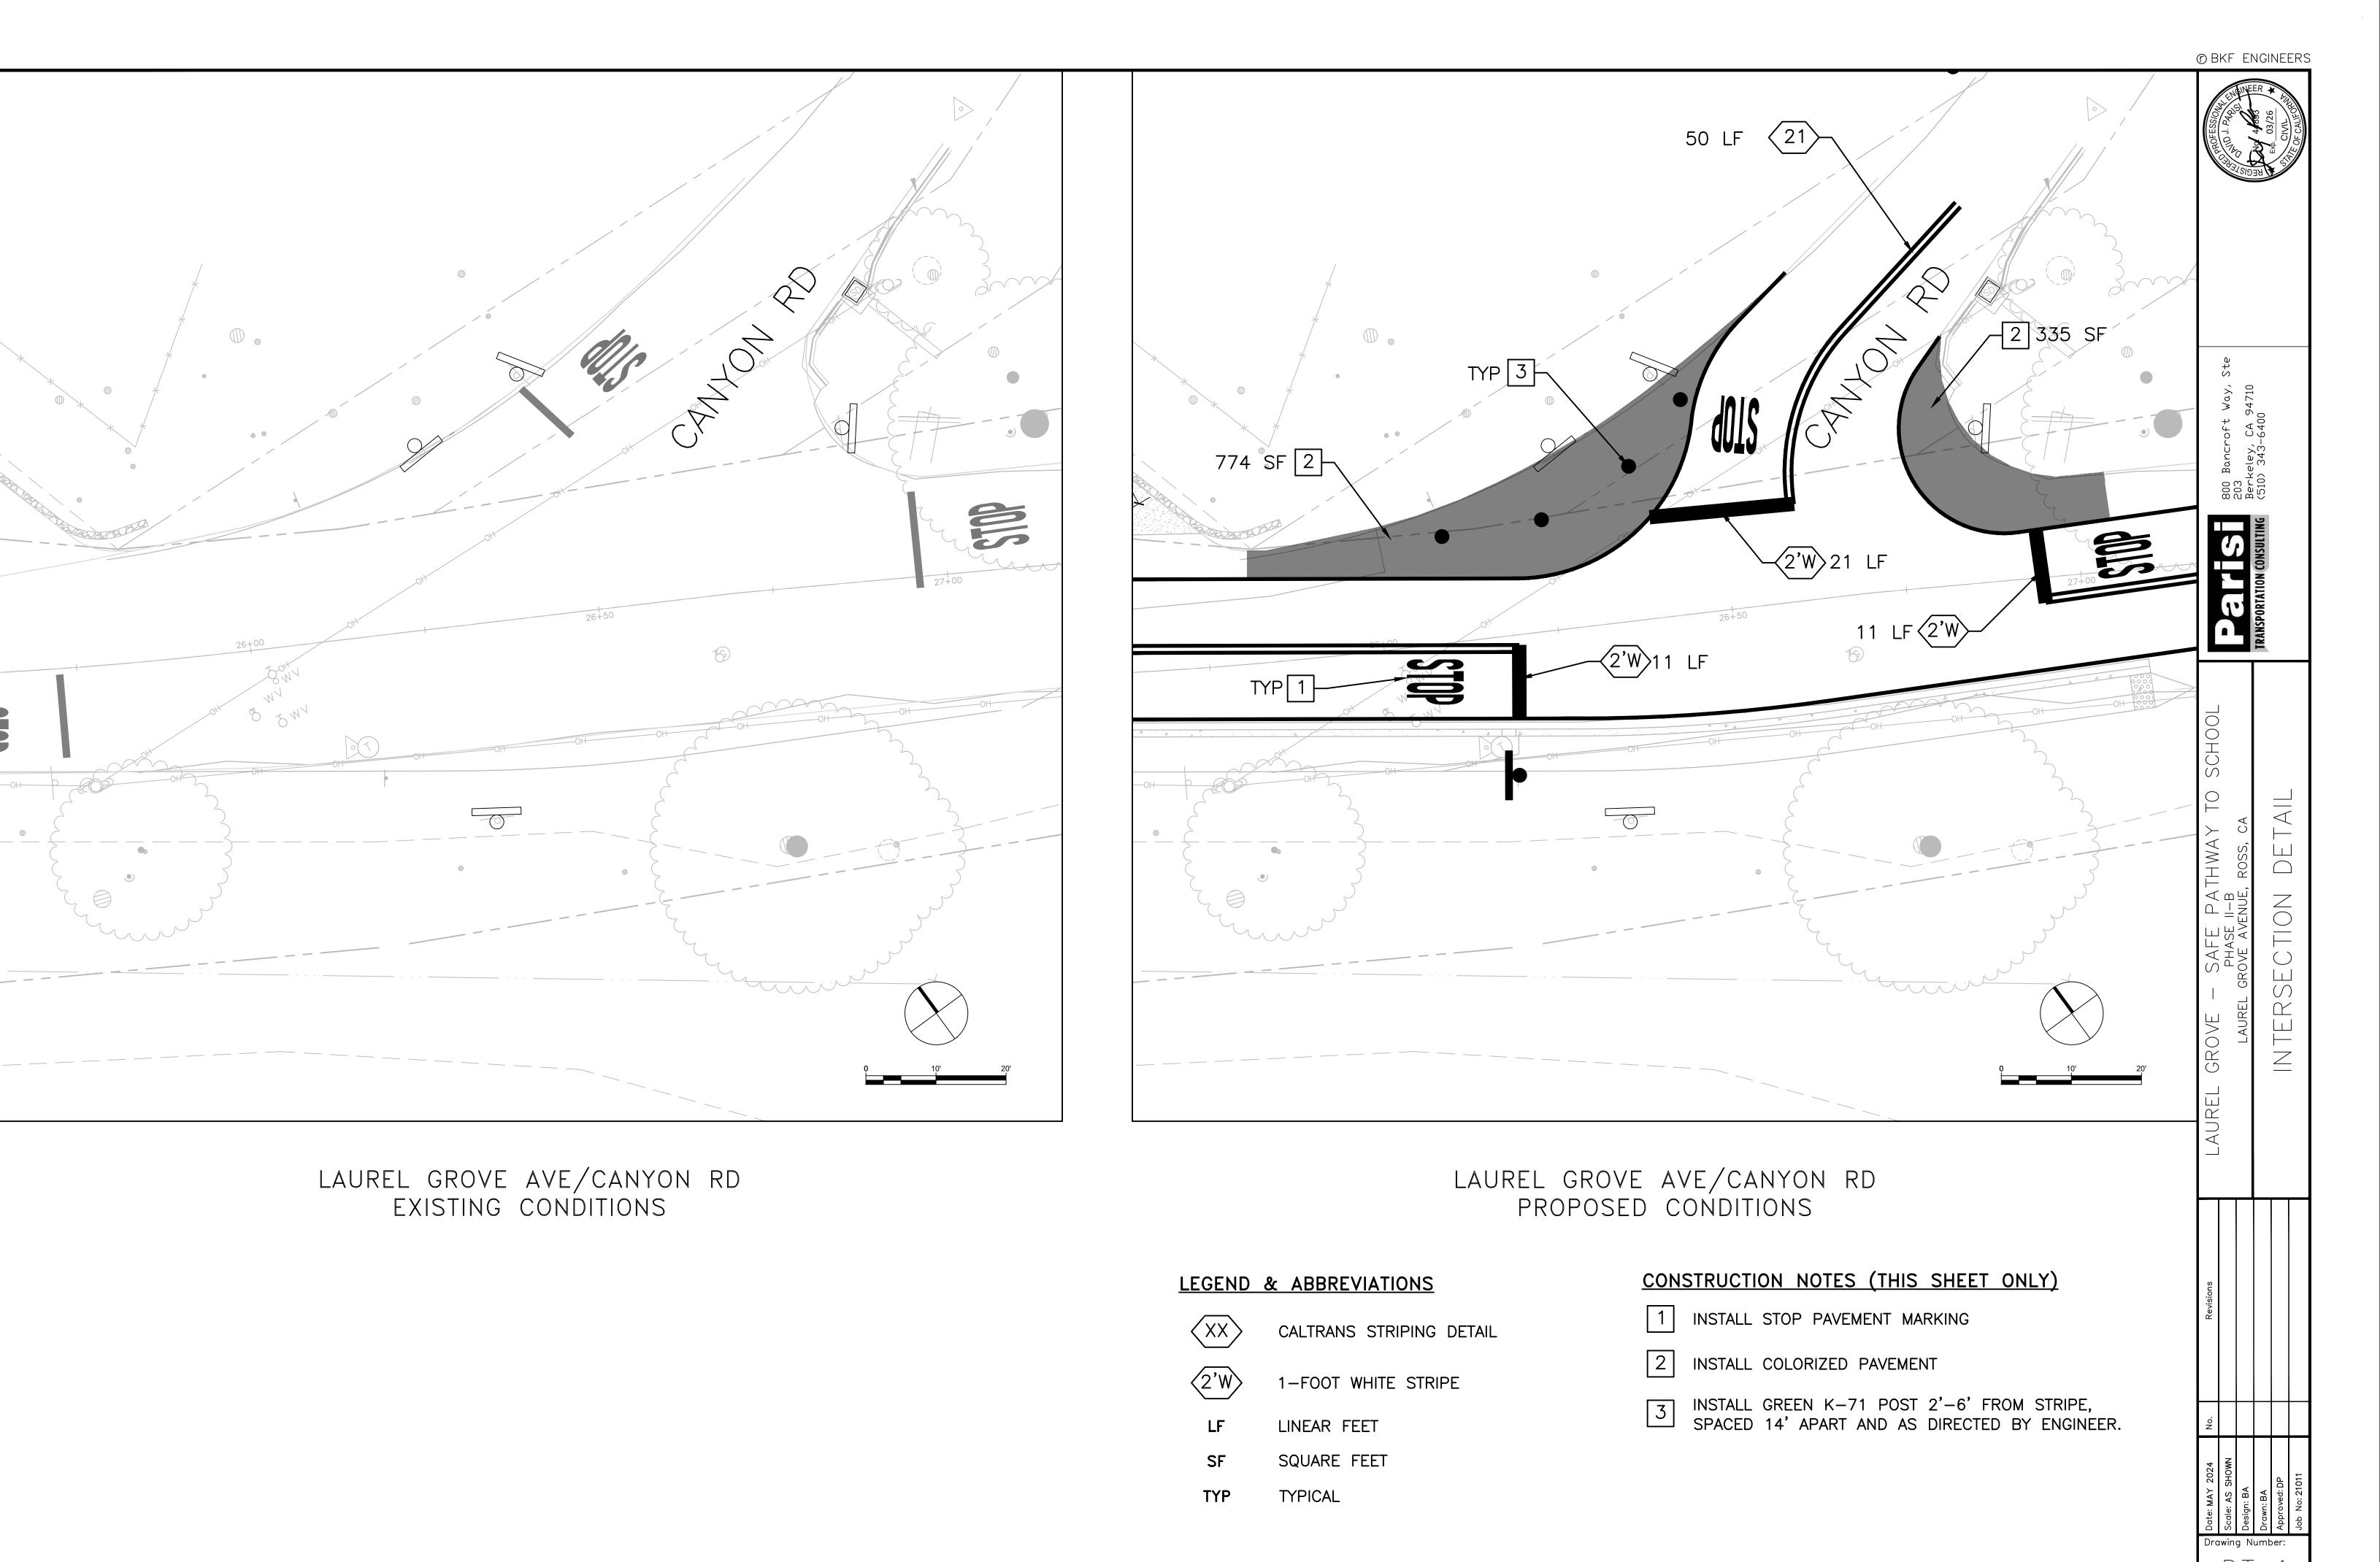

Plot May 03, 2024 at 11:

45


M ENGINEE ENGI

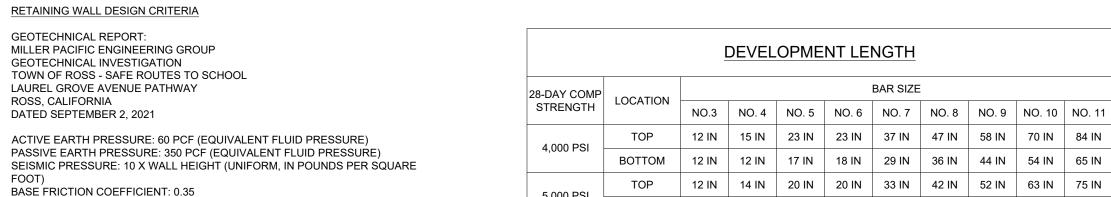

NO. 11 N/A N/A

LAP SPLICE LENGTH										
28-DAY COMP	LOCATION					BAR SIZE				
STRENGTH	LOCATION	NO.3	NO. 4	NO. 5	NO. 6	NO. 7	NO. 8	NO. 9	NO. 10	N
4 000 DCI	TOP	12 IN	20 IN	29 IN	29 IN	48 IN	62 IN	75 IN	91 IN	1
4,000 PSI	воттом	12 IN	15 IN	23 IN	23 IN	37 IN	47 IN	58 IN	70 IN	
5,000 PSI	TOP	12 IN	18 IN	26 IN	26 IN	43 IN	54 IN	67 IN	82 IN	(
	воттом	12 IN	14 IN	20 IN	20 IN	33 IN	42 IN	52 IN	63 IN	

MINIMUM REBAR BEND DIAMETERS (Dmin)

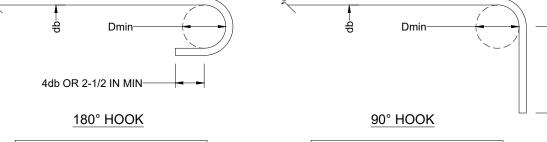

PRINCIPAL REINFORCMENT					
BAR SIZE	Dmin				
NO. 3 TO NO. 8	6 x db				
NO. 9 TO NO. 11	8 x db				
NO. 14 TO NO. 18	10 x db				

	_
HOOPS & STIF	RRUPS
BAR SIZE	Dmin
NO. 3	1-1/2 IN
NO. 4	2 IN
NO. 5	2-1/2 IN


| 12 IN | 14 IN | 20 IN | 20 IN | 33 IN | 42 IN | 52 IN | 63 IN | 75 IN BOTTOM | 12 IN | 12 IN | 16 IN | 26 IN | 32 IN | 40 IN | 49 IN | 58 IN |

HOOKED DEVELOPMENT LENGTH										
28-DAY COMP	LOCATION	BAR SIZE								
STRENGTH	LOCATION	NO.3	NO. 4	NO. 5	NO. 6	NO. 7	NO. 8	NO. 9	NO. 10	
4,000 PSI	N/A	8 IN	10 IN	12 IN	15 IN	17 IN	19 IN	22 IN	24 IN	
5,000 PSI	N/A	7 IN	9 IN	11 IN	13 IN	15 IN	17 IN	20 IN	22 IN	

LAP SPLICE LENGTH												
28-DAY COMP	LOCATION	BAR SIZE										
STRENGTH	LOCATION	NO.3	NO. 4	NO. 5	NO. 6	NO. 7	NO. 8	NO. 9	NO. 10	NO. 11		
4,000 PSI	TOP	12 IN	20 IN	29 IN	29 IN	48 IN	62 IN	75 IN	91 IN	109 IN		
	воттом	12 IN	15 IN	23 IN	23 IN	37 IN	47 IN	58 IN	70 IN	84 IN		
5,000 PSI	TOP	12 IN	18 IN	26 IN	26 IN	43 IN	54 IN	67 IN	82 IN	98 IN		
	воттом	12 IN	14 IN	20 IN	20 IN	33 IN	42 IN	52 IN	63 IN	75 IN		

MINIMUM REBAR B	BEND DIAMETERS (DMIN)
Dmin 4db OR 2-1/2 IN MIN	Dmin—
<u>180° HOOK</u>	90° HOOK ☐
	LICORO A OTIRRUPO

L	4	REINFORCING DETAILS
Ţ		(SCALE: 1" = 10'-0")

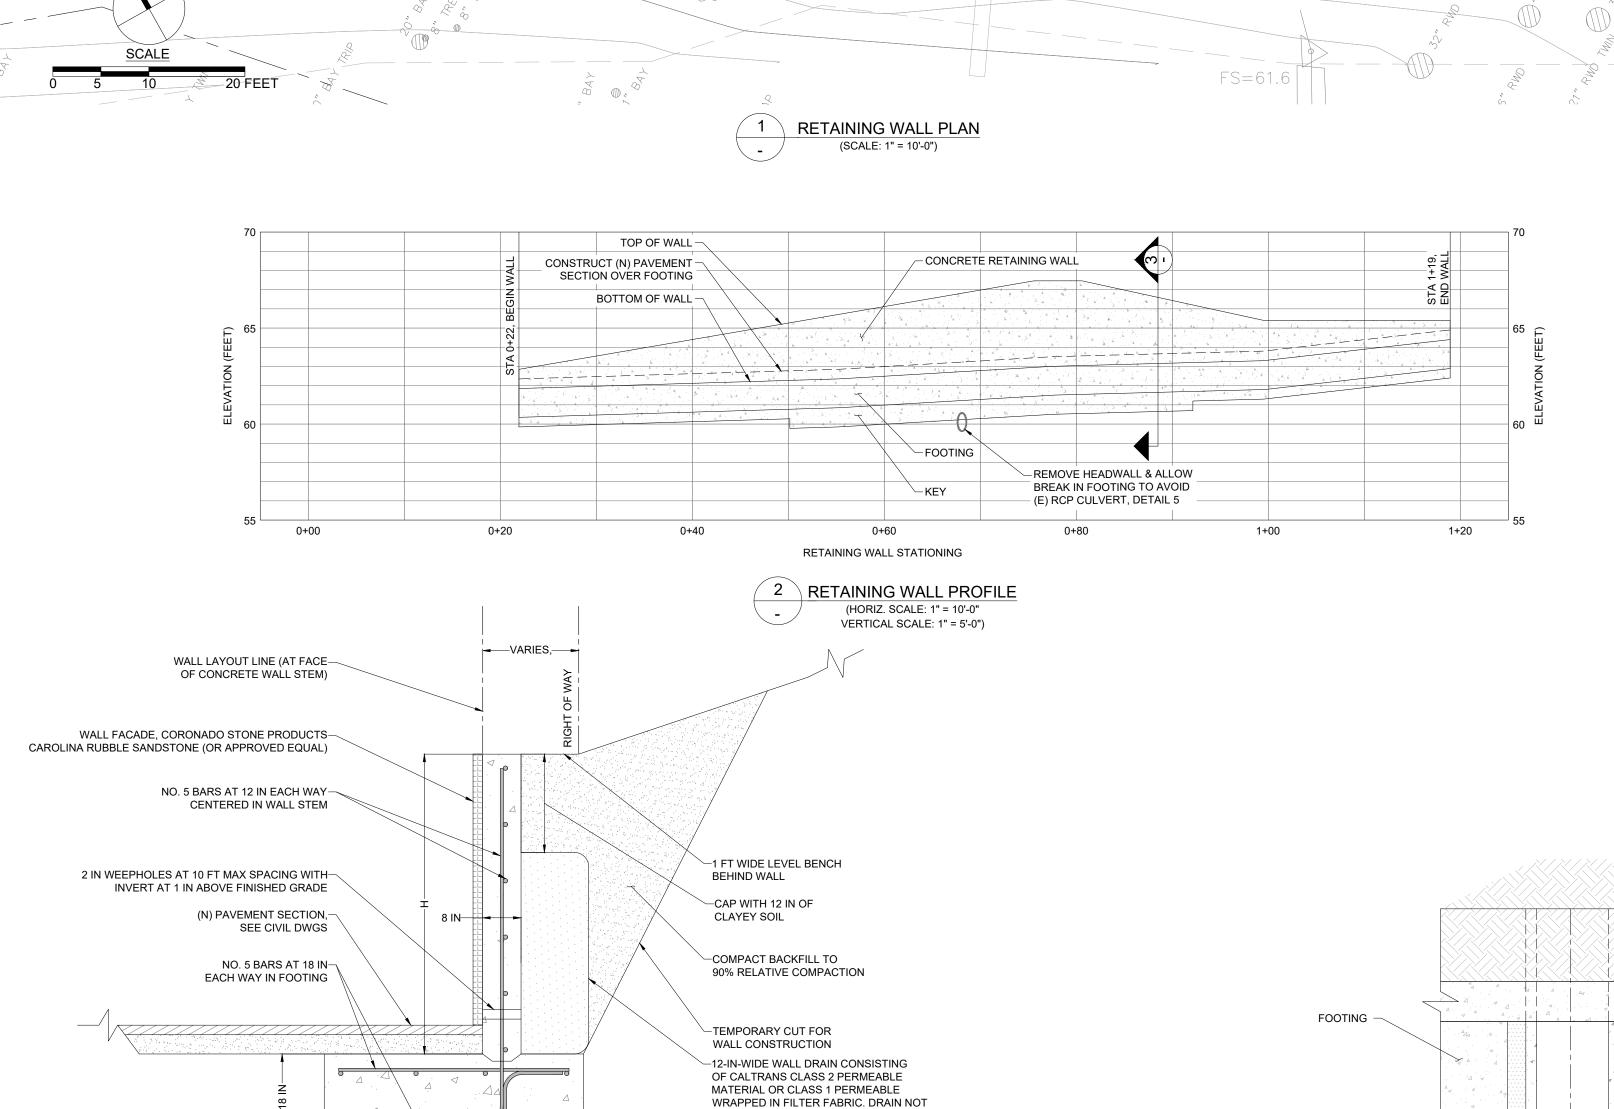

REQUIRED WHERE "H" IS LESS THAN 3 FT

KEY DEPTH, D

6 IN

12 IN

16 IN

WALL HEIGHT, H TOE WIDTH, T

27 IN

36 IN

3 FT OR LESS

4 FT

5 FT

CANTILEVER RETAINING WALL (SCALE: 1" = 10'-0")

(N) CONCRETE

FG 62.3

REMOVE HEADWALL & ALLOW — BREAK IN FOOTING TO AVOID

(E) RCP CULVERT, DETAIL 5.

CONNECT (E) RCP CULVERT TO (E) PLASTIC CULVERT PER CIVIL DWGS

STA 0+22.0 TW 62.9

NO. 5 BARS AT 12 IN-

1912.020 Retaining Wall Drawings, Bid SetC2024E04-12.d2024 BKF ENGINEERS

FOR KEY

FG 62.3

^{S.}1 FT LEVEL BENCH

RETAINING WALL STEM

RETAINING WALL FOOTING

-RIGHT-OF-WAY

STA +92.1 TW 66.2

FG 63.2

(N) PAVEMENT SECTION, SEE CIVIL DWGS CONTINUE WALL STEM ACROSS RCP CULVERT 1 FT WIDE LEVEL BENCH FG OF (N) PAVEMENT = EL 63.0 +/-WALL STEM - CLSM AROUND & ABOVE PIPE FOOTING -- (E) 12 IN RCP CULVERT (E) 12 IN RCP CÚLVERT - CLSM AROUND TOP OF (E) RCP CULVERT = EL 61.0 +/-& ABOVE PIPE

ALLOWABLE BEARING CAPACITY: 3,000 PSF

COMPLY WITH THE PROVISIONS OF ACI 318-14.

3. ALL AGGREGATE SHALL CONCORM TO ASTM C33.

ALL WORK SHALL BE IN ACCORDANCE WITH COUNTY OF MARIN STANDARD

SPECIFICATIONS AND THE LATEST EDITION OF ACI 301: SPECIFICATION FOR STRUCTURAL CONCRETE FOR BUILDINGS. ALL STRUCTURAL CONCRETE SHALL

2. ALL CONCRETE SHALL BE NORMAL WEIGHT AND READY-MIXED WITH A MAXIMUM

5. CONCRETE SHALL HAVE A MINIMUM 28-DAY COMPRESSIVE STRENGTH OF 4,000

3. REINFORCING STEEL BENDS, HOOKS, DEVELOPMENT LENGTHS AND SPLICES SHALL BE IN ACCORDANCE WITH DETAIL 5/SHEET RW1.

1.1 FOUNDATIONS: GEOTECHNICAL ENGINEER SHALL OBSERVE EXCAVATIONS TO CONFIRM SOIL CONDITIONS ARE CONSISTENT WITH GEOTECHNICAL DESIGN

1.2 CONCRETE: CONCRETE SHALL BE SAMPLED, SLUMP SHALL BE MEASURED AND CYLINDERS SHALL BE CAST FOR STRENGTH TESTING IN CONFORMANCE WITH ASTM C39. A MINIMUM OF 1 CYLINDER SHALL BE TESTED AT 7 DAYS AND A

1.3 REINFORCING STEEL: REBAR SHALL BE OBSERVED PRIOR TO PLACEMENT OF

1.4 <u>WALL DRAINAGE</u>: WALL DRAINAGE AND RELATED COMPONENTS SHALL BE OBSERVED PRIOR TO PLACEMENT OF O BACKFILLING.

1.5 WALL BACKFILL: OBSERVATION AND FIELD DENSITY TESTING OF BACKFILL

MINIMUM OF 3 CYLINDERS SHALL BE TESTED AT 28 DAYS

MATERIALS DURING PLACEMENT AND COMPACTION.

STRUCTURAL TESTS AND PERIODIC SPECIAL INSPECTIONS, AS REQUIRED BY THE 2019 CALIFORNIA BUILDING CODE (CBC) CHAPTER 17, SHALL BE PERFORMED BY A QUALIFIED TESTING AND INSPECTION AGENCY, INCLUDING THE FOLLOWING.

4. ALL WATER SHALL BE CLEAN, POTABLE AND NOT DETRIMENTAL TO THE

1. REINFORCING STEEL SHALL CONFORM TO ASTM A615, GR 60.

WATER TO CEMENT RATIO 0.45 AND A MAXIMUM MEASURED SLUMP OF 4 INCHES.

CONCRETE


REINFORCING STEEL

2. PROVIDE 3 IN MINIMUM COVER.

SPECIAL INSPECTIONS

ELEVATION WALL FOOTING AT (E) RCP CULVERT (SCALE: 1" = 10'-0")

Drawing Number:

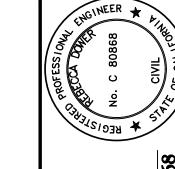

EX AC PAVEMENT (CONDITIONS VARY)

(CONDITIONS VARY)


─ (8" AC PLUG, REFER TO PLAN)


EX AB

BK


DETAIL

Drawing Number:

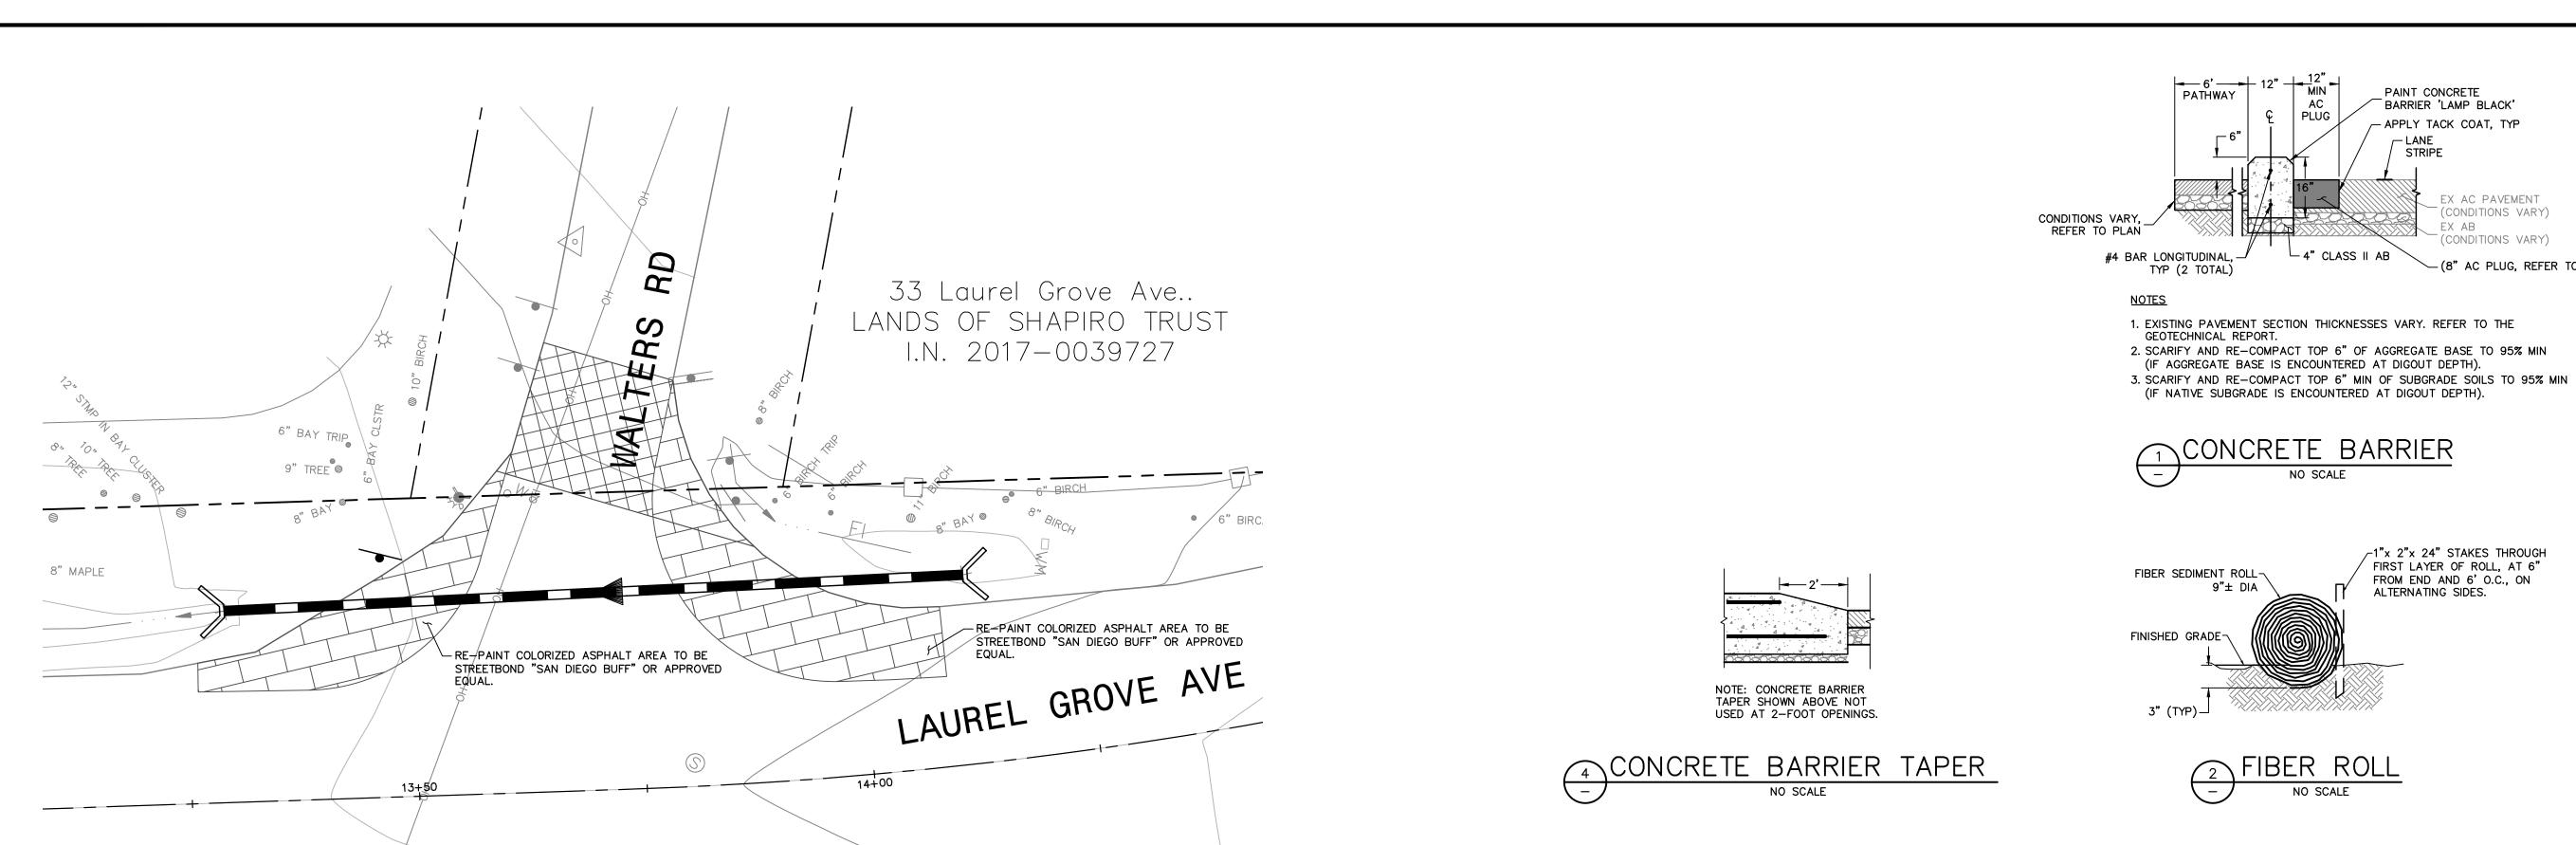


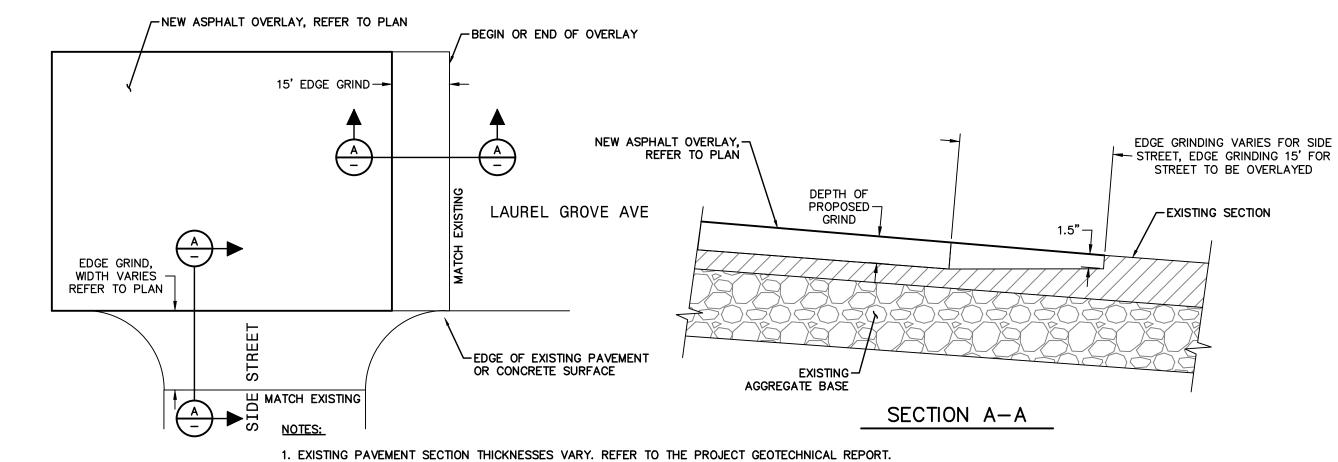

END OF PAVEMENT REHABILITATION CONFORM

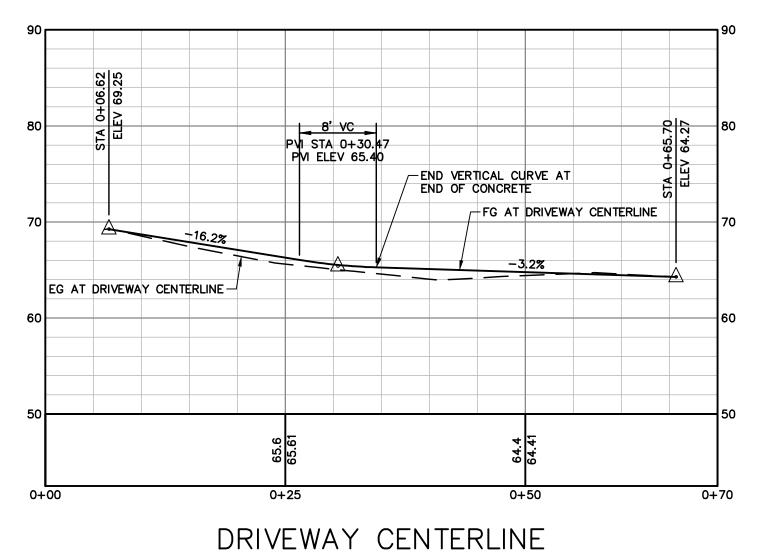

H: 1"=10' V: 1"=10'

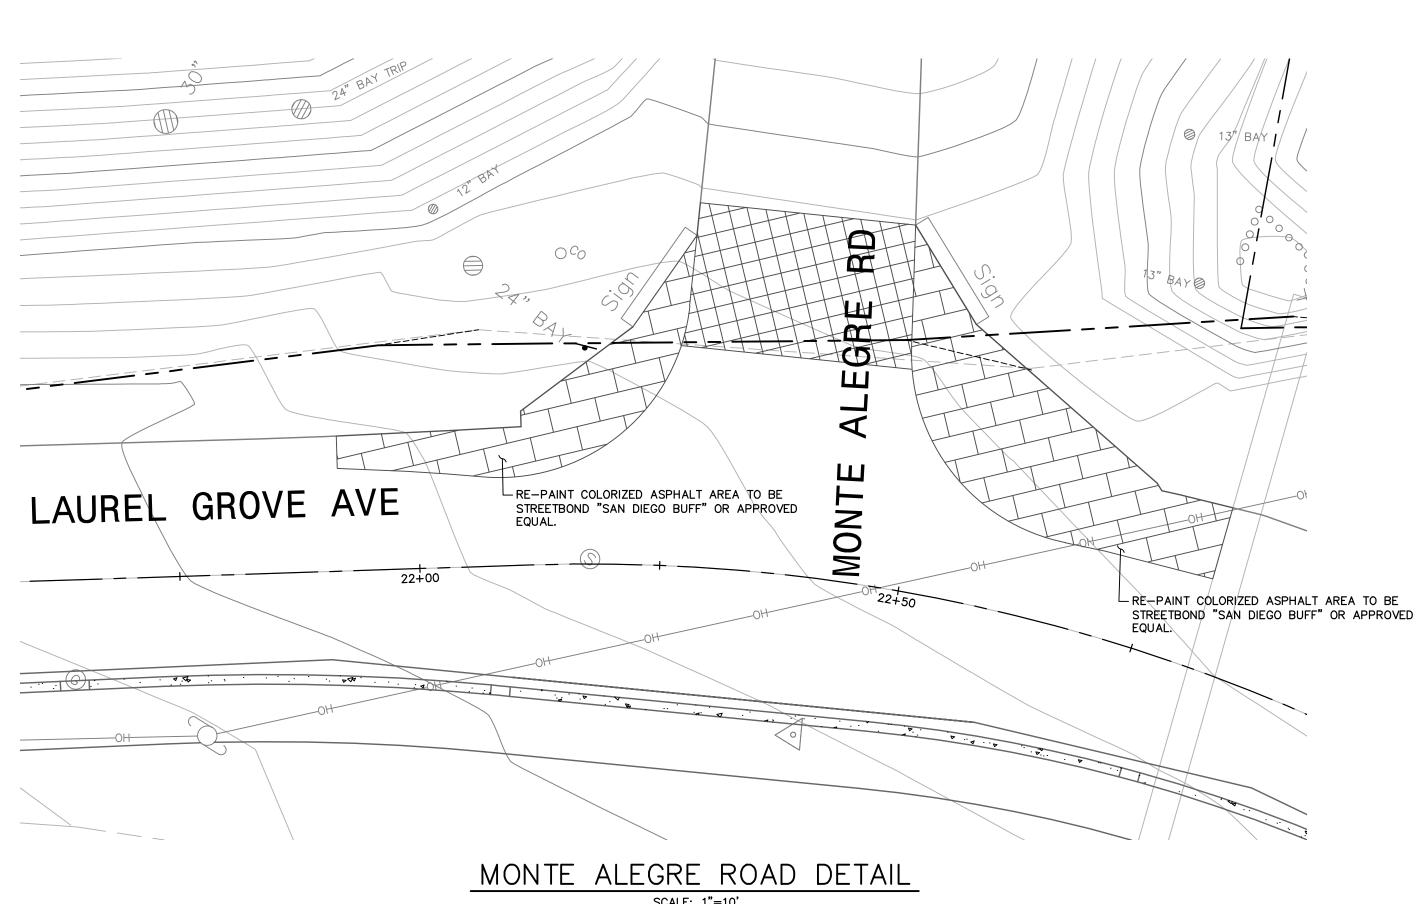

WALTERS ROAD DETAIL

SCALE: 1"=10'

210182-10_IMPR.dwg

NOTE: PRUNUS LAUROCERASUS TO BE CAGED WITH 4-FOOT TALL X 3-FOOT DIAMETER HOG WIRE MESH PANELS W/4" OPENINGS

LEGEND

E = EVERGREEN, D = DECIDUOUS, N = CALIFORNIA NATIVE, W = LOW WATER USE REQUIREMENTS F = LOW FIRE / NON - PYROPHYTIC

NOTE: ALL PLANTS ARE TO BE IRRIGATED UTILIZING DRIP IRRIGATION METHODS


PLAN NOTE

MOST OF THE WORK SHOWN ON THESE LANDSCAPE AND IRRIGATION PLANS OCCURS ON PRIVATE PROPERTY. CONTRACTOR SHALL REFERENCE THE CIVIL IMPROVEMENT DRAWINGS FOR ACTUAL LOCATION AND LIMITS OF PUBLIC RIGHT OF WAY, PROPERTY LINES, AND TEMPORARY CONSTRUCTION EASEMENTS


PLANTING NOTES


TREE PLANTING


- 1. THE TREES SHALL BE SPOTTED AS PER PLAN AND THE LOCATIONS APPROVED PRIOR TO THE DIGGING OF THE HOLES. PLANT MATERIAL TO BE ADJUSTED BY THE LANDSCAPE ARCHITECT PRIOR TO PLANTING.
- ALL PLANTING PITS TO BE TESTED FOR PERCOLATION. PLANT HOLES THAT DO NOT COMPLETELY DRAIN ARE TO RECEIVE PERFORATED PVC DRAINPIPE SET VERTICALLY AND FILLED WITH GRAVEL.
- 3. 24" BOX TREES TO BE STAKED WITH A MINIMUM OF (2) 3" DIAMETER LODGEPOLE TREE STAKES WITH RUBBER VINE TIES. 36" BOX TREES ARE TO BE STAKED WITH A MINIMUM OF (3) 3" DIAMETER LODGEPOLE STAKES WITH RUBBER VINE TIES.
- 4. ALL STAKES ARE TO BE FINISHED WITH 2 COATS OF FLAT BLACK PAINT PRIOR TO INSTALLATION.5. ALL TREES TO RECEIVE AGRIFORM FERTILIZER TABLET PER MANUFACTURER RECOMMENDATIONS.
- 5. ALL TREES TO RECEIVE AGRIFORM FERTILIZER TABLET PER MANUFACTURER RECOMMENDATIONS SHRUB / PERENNIAL PLANTING
- THE SHRUBS SHALL BE SPOTTED AS PER PLAN AND THE LOCATIONS APPROVED PRIOR TO THE DIGGING OF THE HOLES. PLANT MATERIAL TO BE ADJUSTED BY THE LANDSCAPE ARCHITECT PRIOR TO PLANTING.
- ALL PLANTING PITS TO BE TESTED FOR PERCOLATION. PLANT HOLES THAT DO NOT COMPLETELY DRAIN ARE TO RECEIVE PERFORATED PVC DRAINPIPE SET VERTICALLY AND FILLED WITH GRAVEL. MULCH
- 1. NEW LANDSCAPE AREAS ARE TO RECEIVE A 3" LAYER OF ORGANIC MULCH FOLLOWING PLANT INSTALLATION OPERATIONS.
- 2. MULCH TO BE APPROVED BY FIRE DEPARTMENT PRIOR TO DELIVER AND INSTALLATION. MAINTENANCE / GUARANTEE
- 1. THE CONTRACTOR SHALL MAINTAIN THE PROJECT FOR 90 DAYS FOLLOWING COMPLETION. THIS INCLUDES MOWING, FERTILIZING, WEEDING, PRUNING AND FINE TUNING THE IRRIGATION SYSTEM.
- 2. ALL PLANT MATERIAL TO BE GUARANTEED TO BE THRIVING AND HEALTHY DURING THE MAINTENANCE PERIOD. ANY UNHEALTHY PLANTS OR PLANTS THAT HAVE DIED ARE TO BE REPLACED AT NO COST TO THE OWNER. THE CONTRACTOR WILL NOT BE HELD ACCOUNTABLE FOR LOSS OF PLANT MATERIAL DUE TO VANDALISM OR LACK OF CARE BY OTHERS.
- SOIL PREPARATION
- THE LANDSCAPE CONTRACTOR SHALL BE RESPONSIBLE FOR FINISH GRADING AND FOR ALL PLANTING AREA DRAINAGE.
- 2. POSITIVE DRAINAGE AWAY FROM BUILDINGS SHALL BE MAINTAINED. NO LOW SPOTS WHICH HOLD STANDING WATER WILL BE ACCEPTED.
- 3. CONTRACTOR SHALL ENSURE PERCOLATION OF ALL PLANTING PITS PRIOR TO INSTALLATION.
- 4. THE LANDSCAPE CONTRACTOR SHALL INCORPORATE 6 CY OF TOPSOIL AMENDMENT PER 1,000 SF OF PLANTING AREA. IN AREAS OF SHADE AND PART SHADE, AMENDMENT TO BE "RHODODENDRON MIX" BY SBI BUILDING MATERIALS OR EQUAL. IN SUN AREAS, TOPSOIL AMENDMENT TO BE "RAISED BED MIX BY SBI BUILDING MATERIALS OR EQUAL. ROTOTILL THOROUGHLY INTO THE TOP 8" OF SOIL. WHERE ROTO-TILLING IS NOT POSSIBLE, WORK AMENDMENTS INTO THE SOIL USING HAND TOOLS.
- 5. AFTER INSTALLATION OF IRRIGATION SYSTEM, ALL PLANTING AREAS ARE TO BE FINE GRADED TO WITHIN 2" AND SLIGHTLY MOUNDED AWAY FROM EDGES OF CURBS, WALKS, HEADERS, ETC. AND RAKED SMOOTH.

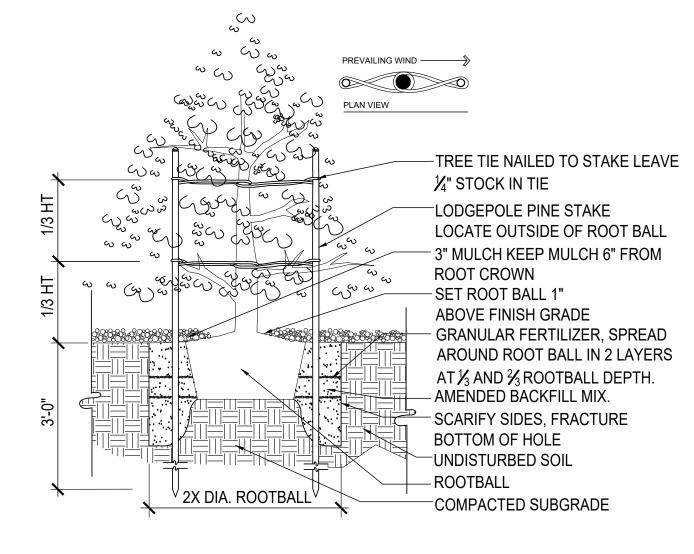



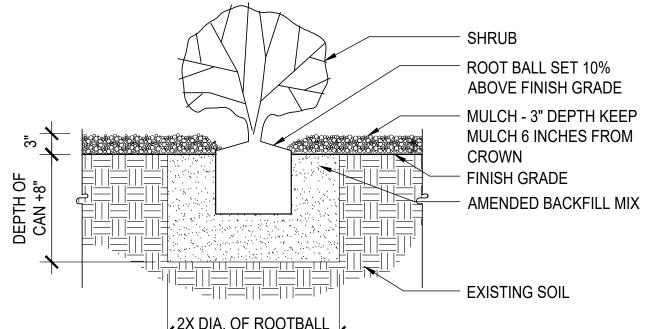

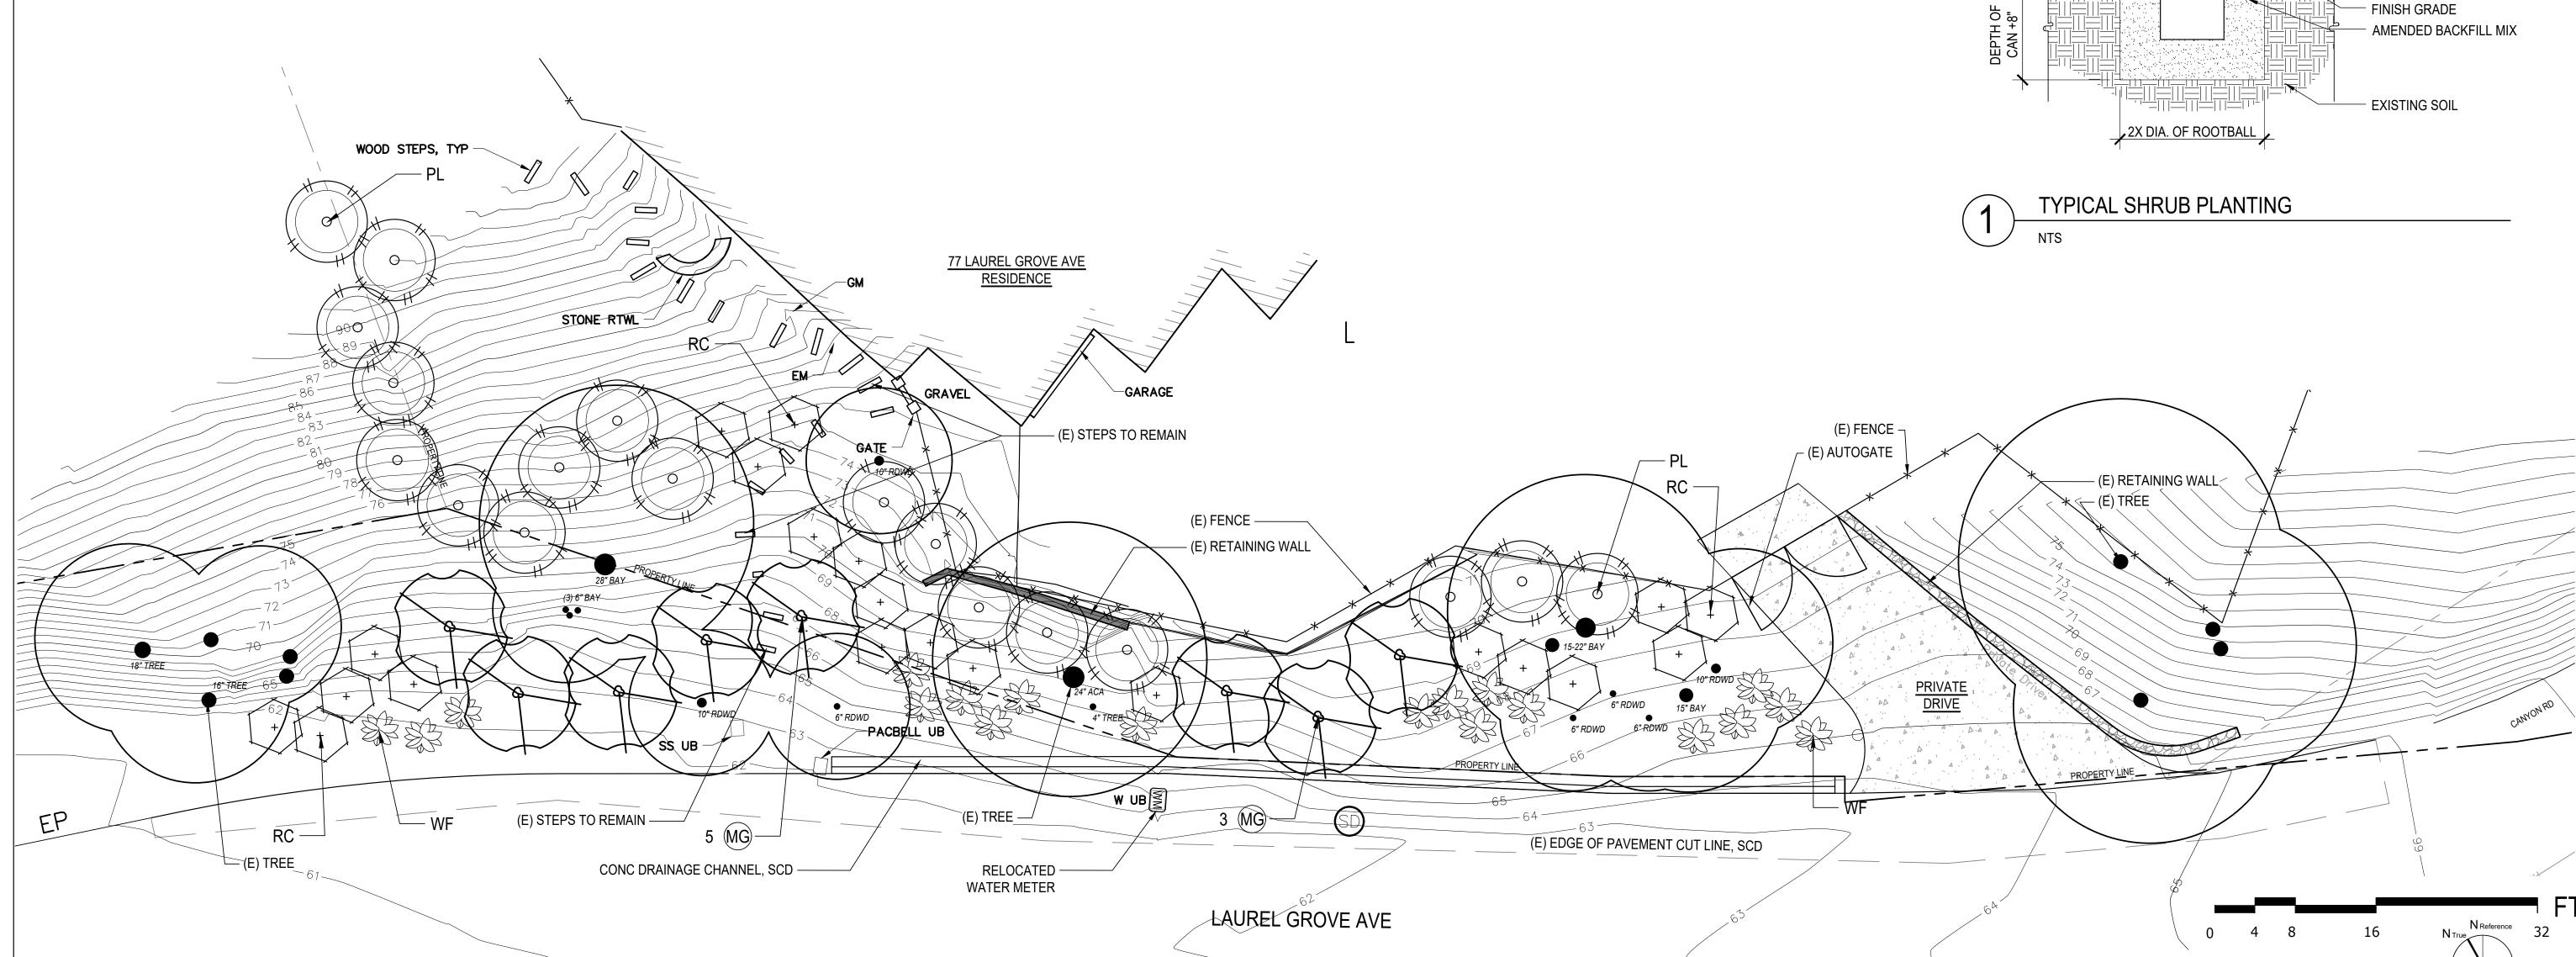

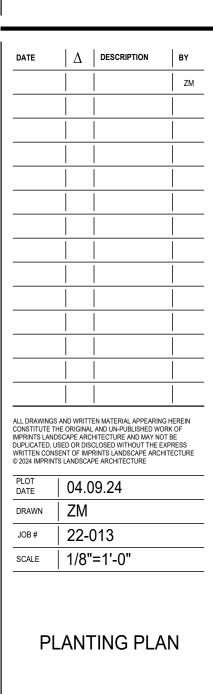

13 OF 14


202 Rosemont Ave Mill (415) 380-0755 brad@imprintsgardens.c

UREL GROVE PATHWA

4

No. 4538

PURPOSES ONLY

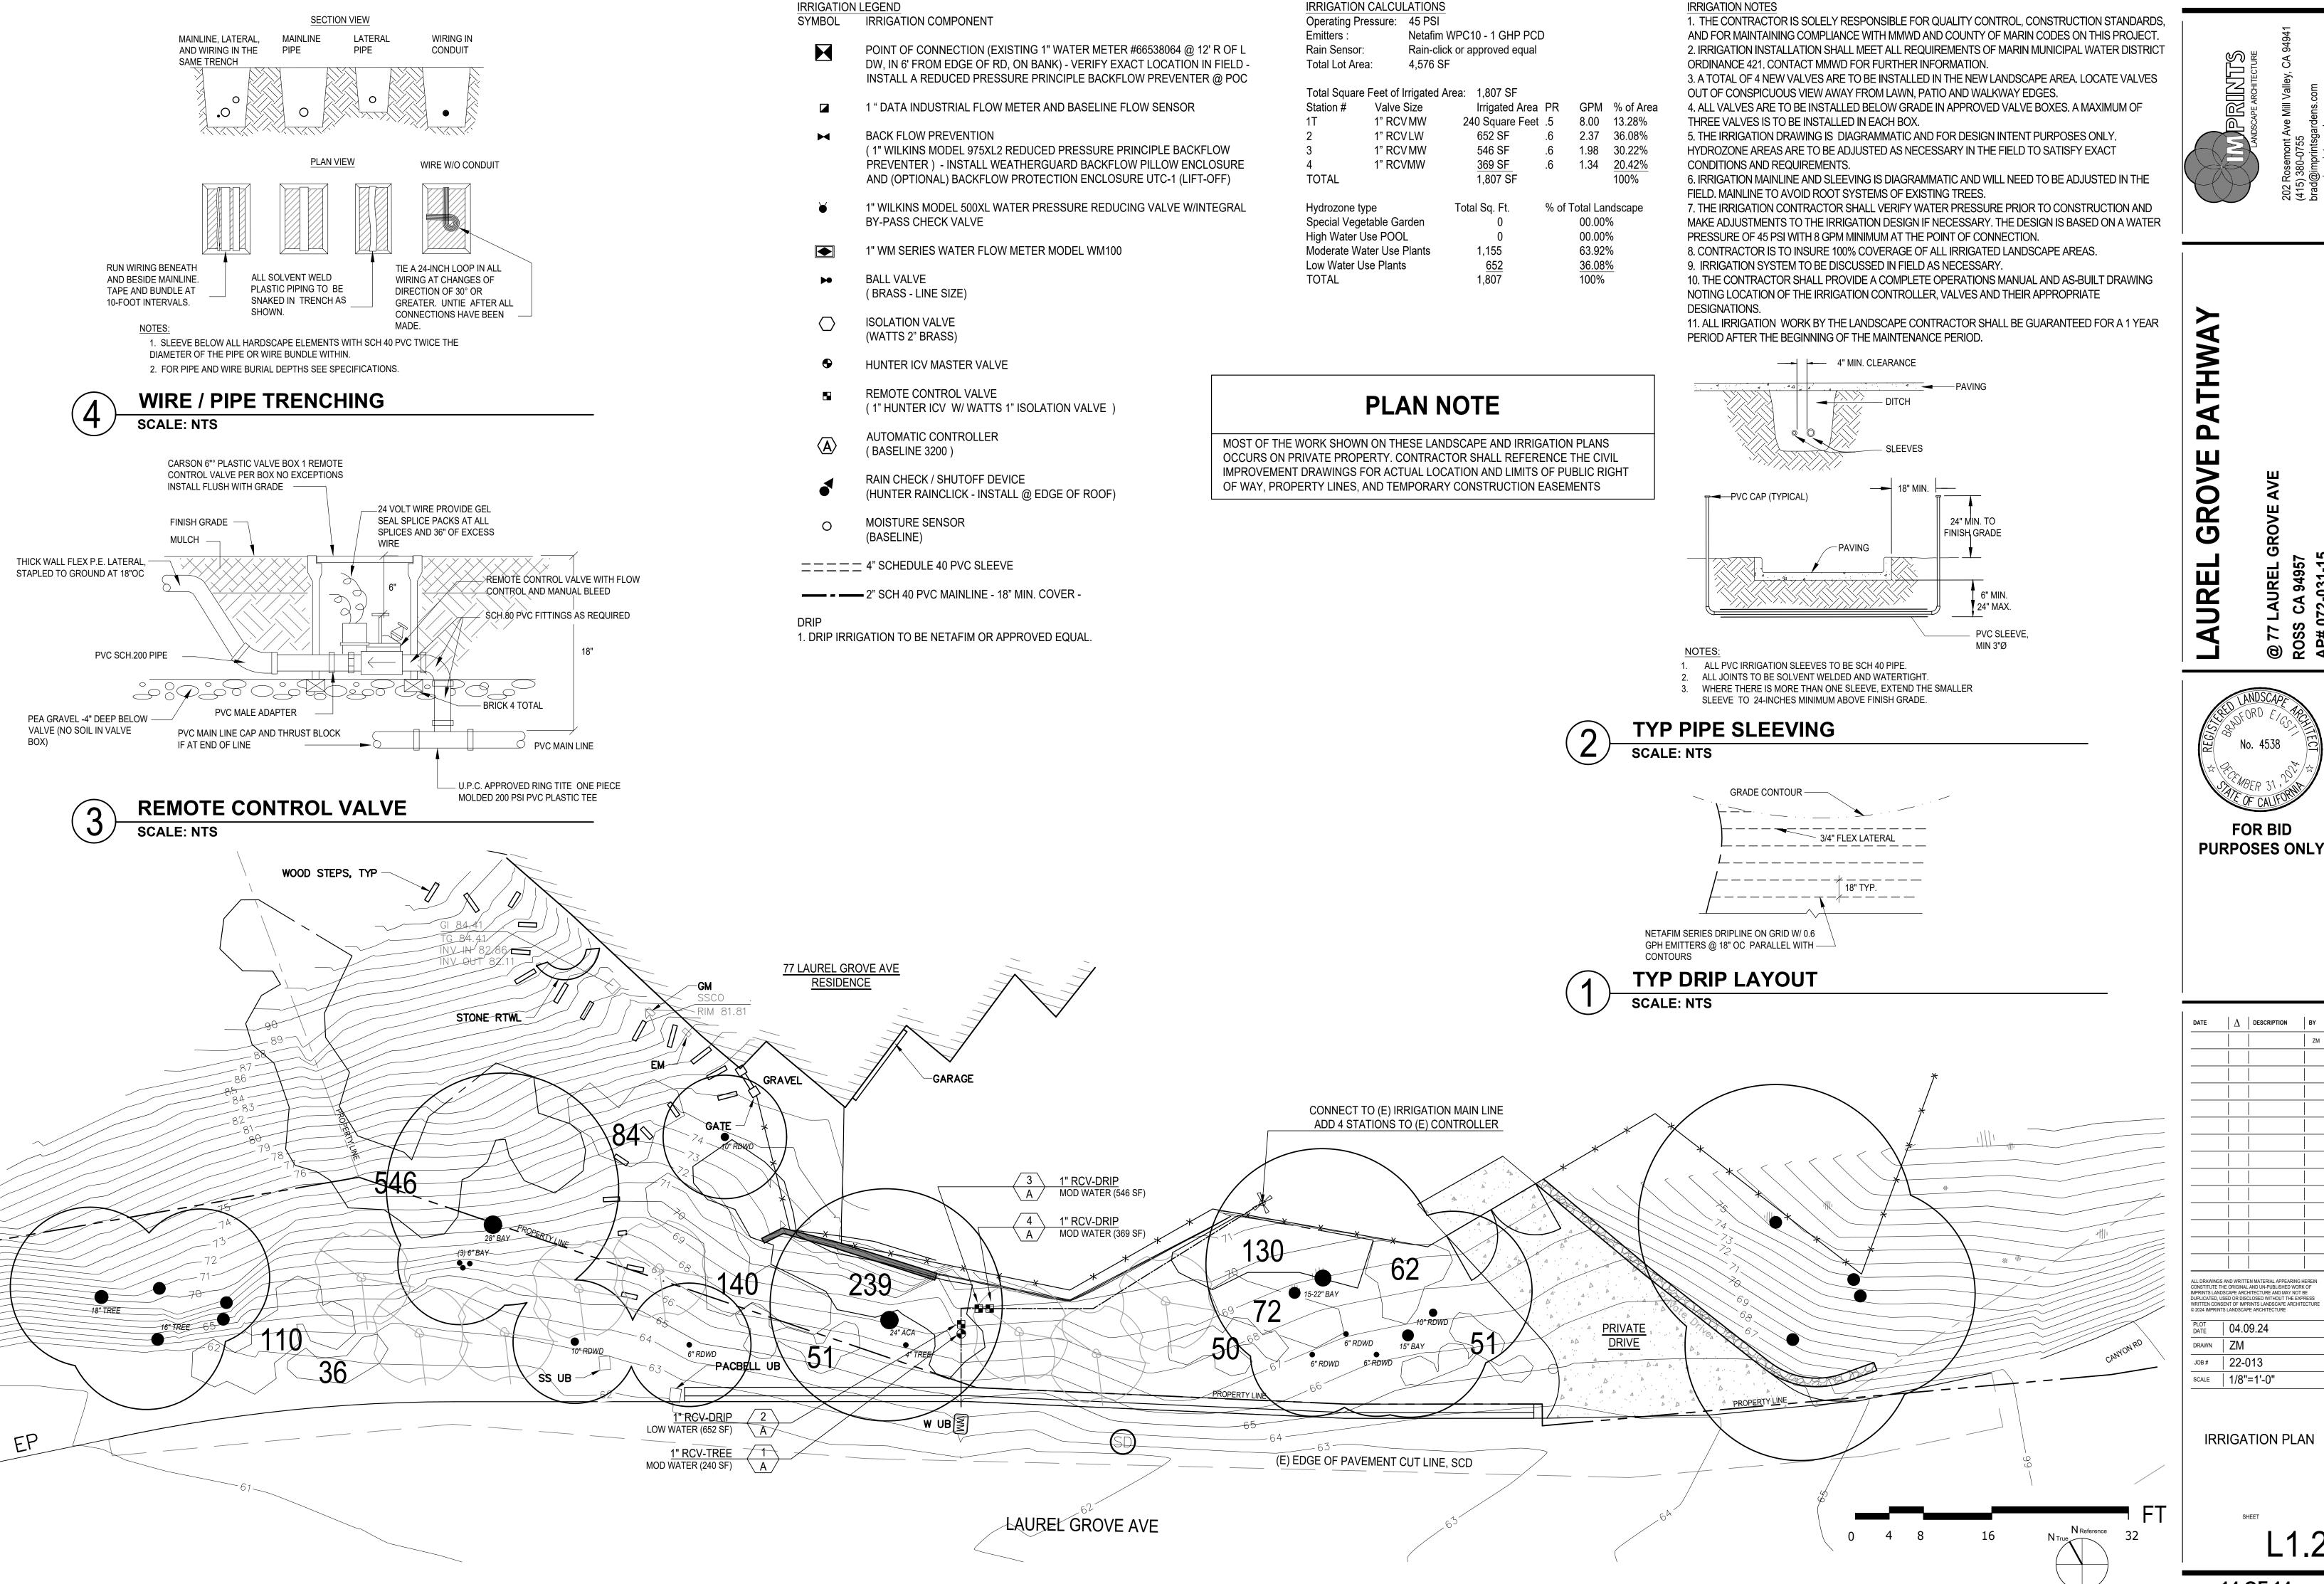

14 OF 14